

LOCATION PLAN SCALE: 1"=500'

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TOWN OF WINCHESTER, MASSACHUSETTS

DEPARTMENT OF PUBLIC WORKS

PROPOSED BRIDGE REPAIRS OF

BRIDGE NO.: W-40-012 (2CH)
WASHINGTON STREET OVER ABERJONA RIVER
AND
BRIDGE NO.: W-40-011 (80B)
CROSS STREET OVER ABERJONA RIVER

JUNE 7, 2023

BID DOCUMENTS



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GENERAL NOTES:

- 1. THE LOCATIONS OF THE EXISTING UNDERGROUND UTILITIES ARE SHOWN IN AN APPROXIMATE WAY ONLY AND HAVE NOT BEEN INDEPENDENTLY VERIFIED BY THE OWNER OR ITS REPRESENTATIVE. THE CONTRACTOR SHALL DETERMINE THE EXACT LOCATION OF ALL EXISTING UTILITIES BEFORE COMMENCING WORK, AND AGREES TO BE FULLY RESPONSIBLE FOR ANY AND ALL DAMAGES WHICH MIGHT BE OCCASIONED BY THE CONTRACTOR'S FAILURE TO EXACTLY LOCATE AND PRESERVE ANY AND ALL UNDERGROUND UTILITIES. THE CONTRACTOR SHALL DIG TEST PITS WITH THE LOCATIONS BEING APPROVED BY THE ENGINEER PRIOR TO COMMENCEMENT OF WORK TO EXACTLY LOCATE THE UTILITIES.
- 2. WHERE AN EXISTING UTILITY IS FOUND TO CONFLICT WITH THE PROPOSED WORK, THE LOCATION, ELEVATION AND SIZE OF THE UTILITY SHALL BE ACCURATELY DETERMINED WITHOUT DELAY BY THE CONTRACTOR AND THE INFORMATION FURNISHED TO THE ENGINEER FOR RESOLUTION OF THE CONFLICT.
- 3. THE CONTRACTOR SHALL MAKE ALL ARRANGEMENTS FOR THE ALTERATION AND ADJUSTMENT OF GAS, ELECTRIC, TELEPHONE AND ANY OTHER PRIVATE UTILITIES BY THE UTILITY OWNER. ANY ALTERATIONS SHALL BE INCIDENTAL TO THE PROJECT. THE CONTRACTOR RESPONSIBLE FOR THE TEMPORARY SUPPORT OF ALL UTILITIES TO REMAIN IN PLACE AND SHALL DESCRIBE IN WRITING, TO THE SATISFACTION OF THE ENGINEER, HIS METHOD OF TEMPORARY SUPPORT.
- AREAS OUTSIDE THE LIMITS OF PROPOSED WORK DISTRIBUTED BY THE CONTRACTOR'S OPERATIONS SHALL BE RESTORED BY THE CONTRACTOR TO THEIR ORIGINAL CONDITION AT THE CONTRACTOR'S EXPENSE.
- 5. THE TERM "PROPOSED (PROP)" INDICATES WORK TO BE CONSTRUCTED USING NEW MATERIALS OR, WHERE APPLICABLE, RE-USING EXISTING MATERIALS IDENTIFIED AS "REMOVE AND RESET (R&R)".
- 6. ALL EXISTING STATE, COUNTY AND TOWN LOCATION LINES AND PRIVATE PROPERTY LINES HAVE BEEN ESTABLISHED FROM AVAILABLE INFORMATION AND THEIR EXACT LOCATION ARE NOT GUARANTEED.
- 7. ALL EXCESS MATERIAL FROM ROADWAY RECONSTRUCTION OR THE EXCAVATION PROCESS SHALL BE REUSED ON SITE OR REMOVED FROM THE SITE AND DISPOSED OF IN A LEGAL AND PROPER MANNER.
- 8. THE CONTRACTOR SHALL CALL DIGSAFE AT 1-888-344-7233 AT LEAT 72 HOURS, SATURDAYS, AND HOLIDAYS EXCLUDED. PRIOR TO EXCAVATING AT ANY LOCATION. A COPY OF THE DIGSAFE PROJECT REFERENCE NUMBER(S) SHALL BE GIVEN TO THE TOWN PRIOR TO EXCAVATION.
- MASSDOT WILL GENERALLY PROVIDE SURVEY WORK AS OUTLINED IN THE 1988 STANDARD SPECIFICATIONS FOR HIGHWAYS AND BRIDGES, SECTION 5.07, CONSTRUCTION STAKINGS, PAGE 18. THE CONTRACTOR SHOULD EMPLOY QUALIFIED PERSONNEL FOR ANY ADDITIONAL LAYOUT.
- 10. JOINTS BETWEEN HOT MIX ASPHALT TRENCH PAVEMENT AND SAWCUT EXISTING PAVEMENT SHALL BE SEALED WITH BITUMEN AND BACKSANDED.
- 11. IF DEEMED NECESSARY DUE TO THE WORK, THE CONTRACTOR SHALL COORDINATE WITH THE TOWN OF WINCHESTER WATER DEPARTMENT, THE WINCHESTER FIRE DEPARTMENT, AND THE ENGINEER FOR APPROVAL OF SHUTTING DOWN ANY EXISTING WATER MAINS AND SHALL ALSO OBTAIN APPROVAL FOR DISRUPTING ANY EXISTING SEWER FLOWS.
- 12. THE CONTRACTOR SHALL BE AWARE THAT ONLY TOWN PERSONNEL ARE ALLOWED TO OPERATE WATER GATES AND HYDRANTS. ANY REQUESTS TO OPERATE THE GATES SHALL BE COORDINATED THROUGH THE ENGINEER.
- 13. THE CONTRACTOR SHALL COORDINATE ANY WORK FOR THE PROJECT WITH ALL ADJACENT/CONCURRENT PROJECTS AND CONTRACTORS.
- 14. THE CONTRACTOR SHALL INSTALL PRIOR TO COMMENCEMENT OF WORK, MAINTAIN, AND REMOVE AT THE END OF THE PROJECT INLET SEDIMENT CONTROL BAGS IN ALL CATCH BASINS, WITHIN OR ADJACENT TO THE PROJECT LIMITS. THE CONTRACTOR SHALL ALSO MAINTAIN SILT FENCE AND COMPOST FILTER TUBES AS SHOWN ON THE PLANS THROUGHOUT THE DURATION OF THE PROJECT AND REMOVE AT THE END.
- 15. ANY GRASS AREAS DISTURBED BY THE WORK SHALL BE RESTORED TO EXISTING OR NEW GROUND COVER MATERIALS AS DIRECTED BY THE ENGINEER. ANY PLANTS, SHRUBS, OR FLOWERS DISTURBED BY THE WORK SHALL BE RESET TO EXISTING CONDITIONS OR REPLACED WITH NEW PLANTS. SHRUBS. OR FLOWERS AS DIRECTED BY THE ENGINEER. ALL WORK TO RESTORE LANDSCAPE AREAS, NEW GROUND COVER MATERIALS, NEW PLANTS, NEW SHRUBS, OR NEW FLOWERS REQUIRED BY THE ENGINEER SHALL BE INCIDENTAL TO THE PROJECT.
- 16. CONTRACTOR TO COORDINATE WITH UTILITY POLE OWNERS IN AREAS WHERE UNDERGROUND UTILITY WORK IS WITHIN CLOSE PROXIMITY AND POSSIBLE UTILITY POLE SHORING IS REQUIRED WHILE INSTALLING PROPOSED UTILITIES.
- 17. RAISE AND ADJUST FRAMES AND GRATES, FRAMES AND COVERS AND GATE BOXES PRIOR TO PAVEMENT OVERLAY, IF REQUIRED.
- 18. CONTRACTOR IS RESPONSIBLE FOR REPLACING ANY PROPERTY PINS THAT ARE DAMAGED OR DESTROYED DURING CONSTRUCTION, TO THEIR LOCATION JUST PRIOR TO CONSTRUCTION.

PAVEMENT MARKINGS SYMBOLS

	. ,	00 0111112020	
	EXISTING	PROPOSED	DESCRIPTION
P		⁴ 1	PAVEMENT ARROW - WHITE
	ONLY	ONLY	LEGEND "ONLY" - WHITE
5		SL	STOP LINE
		<u>cw</u>	CROSSWALK
		SWL	SOLID WHITE LINE
		SYL	SOLID YELLOW LINE
		BWL	BROKEN WHITE LINE
		BYL	BROKEN YELLOW LINE
		<u>DWL</u>	DOTTED WHITE LINE
		<u>DYL</u>	DOTTED YELLOW LINE
		DWLEx	DOTTED WHITE LINE EXTENSION
		DYLEx	DOTTED YELLOW LINE EXTENSION
		DBWL	DOUBLE WHITE LINE
		DBYL	DOUBLE YELLOW LINE

GENERAL SYMBOL	_S	
EXISTING	PROPOSED	DESCRIPTION
	PROPOSED JB	JERSEY BARRIER
JB ∰ ∰	■ JB ■ CB	CATCH BASIN
		CATCH BASIN CURB INLET
⊕ FP	♥ FP	FLAG POLE
G GP	G GP	GAS PUMP
□ MB	□ MB	MAIL BOX
		POST SQUARE
\circ	0	POST CIRCULAR
⊕ WELL	⊕ WELL	WELL
- EHH	□ EHH	ELECTRIC HANDHOLE
o GG	O O GG	FENCE GATE POST GAS GATE
BHL #	BHL#	BORING HOLE
→ MW #	→ MW #	MONITORING WELL
■ TP #	B TP#	TEST PIT
P	P	HYDRANT
*	*	LIGHT POLE
□ CO.BD.		COUNTY BOUND
		GPS POINT
©	©	CABLE MANHOLE
(D)	(D)	DRAINAGE MANHOLE ELECTRIC MANHOLE
(E) (G)	€ ⊚	GAS MANHOLE
M	®	MISC MANHOLE
<u>s</u>	<u>s</u>	SEWER MANHOLE
T	T	TELEPHONE MANHOLE
W	w	WATER MANHOLE
MHB	■ MHB	MASSACHUSETTS HIGHWAY BOUND
□ MON		MONUMENT
□ SB		STONE BOUND
■ TB		TOWN OR CITY BOUND TRAVERSE OR TRIANGULATION STATION
△ ⊸ TPL or GUY	→ TPL or GUY	TROLLEY POLE OR GUY POLE
• HTP	0 11 2 01 001	TRANSMISSION POLE
-6- UFB	- ⊹ UFB	UTILITY POLE W/ FIREBOX
-\$- UPDL	-∳- UPDL	UTILITY POLE WITH DOUBLE LIGHT
6 ULT	_&_ ULT	UTILITY POLE W / 1 LIGHT
-o- UPL	- > UPL	UTILITY POLE
0		BUSH
•SIZE & TYPE		TREE
		STUMP SWAMP / MARSH
• WG	• WG	WATER GATE
• PM	• PM	PARKING METER
		- OVERHEAD CABLE/WIRE
		= CURBING
_100		- CONTOURS (ON-THE-GROUND SURVEY DATA)
		- CONTOURS (PHOTOGRAMMETRIC DATA)
		- UNDERGROUND DRAIN PIPE (DOUBLE LINE 24 INCH AND OVER) - UNDERGROUND ELECTRIC DUCT (DOUBLE LINE 24 INCH AND OVER)
		- UNDERGROUND GAS MAIN (DOUBLE LINE 24 INCH AND OVER)
		- UNDERGROUND SEWER MAIN (DOUBLE LINE 24 INCH AND OVER)
		- UNDERGROUND TELEPHONE DUCT (DOUBLE LINE 24 INCH AND OVER)
		- UNDERGROUND WATER MAIN (DOUBLE LINE 24 INCH AND OVER)
		BALANCED STONE WALL
		GUARD RAIL - STEEL POSTS
		- GUARD RAIL - WOOD POSTS
		GUARD RAIL - DOUBLE FACE - STEEL POSTS
		- GUARD RAIL - DOUBLE FACE - WOOD POSTS - CHAIN LINK OR METAL FENCE
		- WOOD FENCE
		· HAY BALES/SILT FENCE
		- SAWCUT LINE
		TOP OR BOTTOM OF SLOPE
		- LIMIT OF EDGE OF PAVEMENT OR COLD PLANE AND OVERLAY
		RANK OF RIVER OR STREAM

BANK OF RIVER OR STREAM

200 FT RIVERFRONT BUFFER

TOWN OR CITY BOUNDARY LINE

PROPERTY LINE OR APPROXIMATE PROPERTY LINE

BORDER OF WETLAND

100 FT WETLAND BUFFER

— STATE HIGHWAY LAYOUT

— TOWN OR CITY LAYOUT

_____ COUNTY LAYOUT

— — — — — — EASEMENT

—— P———

----RAILROAD SIDELINE

ARREVIATIONS

ABBREVIATIONS				
GENERAL				
AADT	ANNUAL AVERAGE DAILY TRAFFIC			
ABAN	ABANDON			
\ DJ	ADJUST			
APPROX.	APPROXIMATE			
A.C.	ASPHALT CONCRETE			
ACCM PIPE	ASPHALT COATED CORRUGATED METAL PIPE			
BIT.	BITUMINOUS			
3C	BOTTOM OF CURB			
BD.	BOUND			
3L	BASELINE			
BLDG	BUILDING			
3M	BENCHMARK			
30	BY OTHERS			
BOS	BOTTOM OF SLOPE			
BR.	BRIDGE			
CB	CATCH BASIN			
CBCI	CATCH BASIN WITH CURB INLET			
CC	CEMENT CONCRETE			
CCM	CEMENT CONCRETE MASONRY			
CEM	CEMENT			
CI	CURB INLET			
CIP	CAST IRON PIPE			
C.I.P.	CAST IN PLACE			
CLF	CHAIN LINK FENCE			
CL	CENTERLINE			
CMP	CORRUGATED METAL PIPE			
CSP	CORRUGATED STEEL PIPE			
CO.	COUNTY			
CONC	CONCRETE			
CONT	CONTINUOUS			

CONSTRUCTION **CROWN GRADE** DESIGN HOURLY VOLUME DROP INLET DIAMETER DUCTILE IRON PIPE STEADY DON'T WALK - PORTLAND ORANGE

DW DWY DRIVEWAY ELEV (or EL.) ELEVATION **EMBANKMENT EDGE OF PAVEMENT** EXIST (or EX) EXISTING EXC **EXCAVATION** FRAME AND COVER FRAME AND GRATE FDN. **FOUNDATION** FLDSTN **FIELDSTONE**

GARAGE

CONST

CR GR

DHV

DIP

GAR

HDW

PCC

POT

GD GROUND **GAS GATE** GI **GUTTER INLET** GIP **GALVANIZED IRON PIPE** GRAN GRANITE GRAV GRAVEL GRD GUARD

HMA HOT MIX ASPHALT HORIZONTAL HYD **HYDRANT** INVERT INV JCT JUNCTION LENGTH OF CURVE **LEACH BASIN** LIGHT POLE LT LEFT

HEADWALL

MAX MAXIMUM MB MAILBOX MH **MANHOLE** MHB MASSACHUSETTS HIGHWAY BOUND MIN MINIMUM

NIC NOT IN CONTRACT NO. NUMBER PC POINT OF CURVATURE

P.G.L. PROFILE GRADE LINE Ы POINT OF INTERSECTION POC POINT ON CURVE

POINT ON TANGENT

POINT OF COMPOUND CURVATURE

PRC POINT OF REVERSE CURVATURE PROJ PROJECT

PROP PROPOSED PLANTABLE SOIL BORROW

PT POINT OF TANGENCY PVC POINT OF VERTICAL CURVATURE PVI POINT OF VERTICAL INTERSECTION PVT POINT OF VERTICAL TANGENCY

PVMT PAVEMENT PWW PAVED WATER WAY ABBREVIATIONS (cont.)

GENERAL RADIUS OF CURVATURE R&D REMOVE AND DISPOSE RCP REINFORCED CONCRETE PIPE RD ROAD ROADWAY REM REMOVE RETAIN

RET WALL RETAINING WALL RIGHT OF WAY RR RAILROAD R&R REMOVE AND RESET R&S REMOVE AND STACK RT RIGHT SB STONE BOUND SHLD SHOULDER **SMH** SEWER MANHOLE

ST STREET STA STATION SSD STOPPING SIGHT DISTANCE SHLO STATE HIGHWAY LAYOUT LINE SW SIDEWALK TANGENT DISTANCE OF CURVE/TRUCK % TAN

TANGENT TEMP TEMPORARY TOP OF CURB TOS TOP OF SLOPE TYP TYPICAL **UTILITY POLE** VAR **VARIES** VERTICAL VERTICAL CURVE WCR WHEEL CHAIR RAMP WATER GATE

WIP WROUGHT IRON PIPE WATER METER/WATER MAIN X-SECT

CROSS SECTION

UP


VC

WG

TOWN OF WINCHESTER WINCHESTER, MA

WASHINGTON ST & CROSS ST OVER ABERJONA RIVER

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AS SHOWN 06/07/2023 Drawn By: SRG KAC XXX Approved By: W&S Project No.: ENG21 - 1288 W&S File No.:

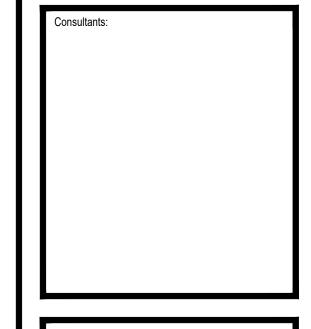Drawing Title:

GENERAL NOTES, LEGEND & **ABBREVIATIONS**

Sheet Number:



EROSION CONTROL NOTES:

TOP LOAD LINE

- FLOTATION DEVICE

CONNECTION -

SECTON VIEW

GROMMETS

(OPTIONAL)

- BALLAST LINE

(GALVANIZED CHAIN)

IT IS THE INTENT OF THE CONTRACT PLANS AND DETAILS TO CONTROL EROSION AND SEDIMENTATION IN ALL PORTIONS OF THE SITE. THE CONTRACTOR IS ALERTED THAT CONTROL OF EROSION AND SEDIMENTATION IS CONSIDERED TO BE ESPECIALLY IMPORTANT IN AND AROUND THE AREAS SHOWN ON THE PLANS AND DELINEATED AS WETLANDS AND WATERCOURSES. THE CONTRACTOR IS TO IMPLEMENT THE EROSION AND SEDIMENTATION CONTROLS INDICATED ON THE PLANS IN ACCORDANCE WITH THE FOLLOWING NOTES, BUT IS ALERTED TO THE FACT THAT ADDITIONAL MEASURES MAY BE REQUIRED TO COMPLY WITH THIS INTENT, AS FIELD CONDITIONS MAY WARRANT. SHOULD SUCH MEASURES BE DETERMINED TO BE REQUIRED OR ORDERED BY THE ENGINEER, THEY ARE TO BE IMPLEMENTED IMMEDIATELY. ANY AND ALL REQUIREMENTS FOR ANY TYPE OF EROSION CONTROL MEASURES SHALL BE INCIDENTAL TO THE PROJECT.

1. ALL WORK SHALL BE IN ACCORDANCE WITH THE CONTRACT DOCUMENTS. THE PROVISIONS OF ALL APPLICABLE PERMITS AND APPROVALS ISSUED BY LOCAL AND STATE REGULATION FOR ACTIVITIES INVOLVING WETLANDS. WATERCOURSES AND/OR EROSION CONTROLS, AND AS DIRECTED BY THE ENGINEER. ALL EROSION AND SEDIMENTATION CONTROL MEASURES SHALL BE CONSTRUCTED IN ACCORDANCE WITH THE MASS DEP'S EROSION AND SEDIMENTATION CONTROL GUIDELINES, AUGUST, 1983 AND THE U.S.D.A. SCS'S EROSION AND SEDIMENT CONTROL IN SITE DEVELOPMENT, MASSACHUSETTS CONSERVATION GUIDE, SEPTEMBER 1983.

2. TEMPORARY EROSION AND SEDIMENTATION CONTROL MEASURES SHALL BE INSTALLED PRIOR TO THE COMMENCEMENT OF ANY SITEWORK, SHALL BE MAINTAINED DURING CONSTRUCTION, AND SHALL REMAIN IN PLACE UNTIL ALL SITEWORK IS COMPLETED AND GROUND COVER IS ESTABLISHED (AT LEAST 75% UNIFORM COVERAGE BY NEW SEEDLINGS).

3. ALL EROSION AND SEDIMENTATION CONTROL MEASURES SHALL BE MAINTAINED IN EFFECTIVE CONDITION THROUGHOUT THE CONSTRUCTION PERIOD. THE CONTRACTOR SHALL INSPECT THE EROSION CONTROLS DAILY AND CLEAN ACCUMULATED MATERIALS FROM BEHIND THEM, AS NECESSARY. ALL EROSION AND SEDIMENTATION CONTROL MEASURES FOUND TO BE IN NEED OF REPAIR OR REPLACEMENT SHALL BE IMMEDIATELY CORRECTED, SO AS TO MAINTAIN THE INTEGRITY OF THE EROSION AND SEDIMENTATION CONTROL SYSTEM.

4. SEDIMENT REMOVED FROM CONTROL STRUCTURES SHALL BE DISPOSED OF IN A MANNER WHICH IS CONSISTENT WITH THE INTENT OF THESE PLANS. NO EQUIPMENT OR MATERIAL OF ANY KIND SHALL BE STOCKPILED OR DEPOSITED IN ANY REGULATED AREA UNLESS SPECIFICALLY SHOWN ON THE CONTRACT PLANS OR AUTHORIZED BY PROJECT PERMITS/APPROVALS.

5. STOCKPILED SOIL SHALL BE SURROUNDED WITH STAKED STRAW BALES AND SILTATION FENCES TO PREVENT AND CONTROL SILTATION AND EROSION. STOCKPILES THAT WILL REMAIN EXPOSED FOR MORE THAN 30 DAYS SHALL BE STABILIZED WITH MULCH OR SEEDED FOR TEMPORARY VEGETATIVE COVER.

6. ALL DISTURBED AREAS THAT WILL REMAIN EXPOSED OR UNDISTURBED FOR A PERIOD OF FOURTEEN (14) DAYS OR LONGER, SHALL BE STABILIZED WITH MULCH OR SEEDED FOR TEMPORARY VEGETATIVE COVER.

CONNECTOR

- BOTTOM SEDIMENT

WATER LEVEL-7

7. STRAW BALE BARRIERS, COMPOST FILTER TUBES OR EQUIVALENT BARRIER APPROVED BY THE ENGINEER, SHALL BE PLACED AROUND CATCH BASIN INLETS DURING CONSTRUCTION AND SHALL BE MAINTAINED UNTIL CONTRIBUTING AREAS ARE PAVED. SILT FENCE BARRIERS, OR EQUIVALENT BARRIER APPROVED BY THE ENGINEER SHALL BE PLACED BETWEEN FRAMES AND GRATES TO PREVENT ANY TYPE OF SILT RUN-OFF INTO ANY EXISTING OR NEW CATCH BASINS.

8. THE CONTRACTOR SHALL INSPECT ALL PORTIONS OF THE SITE IN ANTICIPATION OF RAINFALL EVENTS TO DETERMINE IF SITE GRADING IS SUFFICIENT TO PREVENT EROSION OF SLOPES OR WATERCOURSES WITHIN THE PROJECT LIMITS. SHOULD ADDITIONAL MEASURES BE REQUIRED, THEY ARE TO BE IMPLEMENTED IMMEDIATELY. IN NO CASE SHALL THE INSTALLATION OF ADDITIONAL MEASURES NECESSARY TO PROTECT SLOPES WITHIN THE PROJECT LIMITS BE DELAYED BEYOND THE COMMENCEMENT OF PRECIPITATION.

9. ALL DISTURBED EARTH SLOPES SHALL BE STABILIZED WITH PERMANENT VEGETATIVE COVER AS SOON AS POSSIBLE. DISTURBED AREAS THAT ARE NOT SUBJECT TO CONSTRUCTION TRAFFIC SHALL RECEIVE A PERMANENT OR TEMPORARY VEGETATIVE COVER AS SOON AS FINAL CONTOURS ARE ESTABLISHED. IF THE SEASON PREVENTS THE ESTABLISHMENT OF A VEGETATIVE COVER, DISTURBED AREAS SHALL BE THOROUGHLY MULCHED. MULCHED AREAS SHALL BE SEEDED AS SOON AS WEATHER CONDITIONS ALLOW.

10. A STOCKPILE OF ADDITIONAL COMPOST TUBES, SILTATION FENCE AND CRUSHED STONE SHALL BE KEPT ON SITE THROUGHOUT THE CONSTRUCTION WORK. THIS MATERIAL SHALL BE INSTALLED AT THE DIRECTION OF THE ENGINEER TO MITIGATE ANY EROSION/SEDIMENTATION CONDITIONS WHICH MAY ARISE.

11. FOR DESCRIPTION, MATERIALS, AND CONSTRUCTION METHOD, SEE SPECIAL PROVISIONS. FOR LOCATION OF PROPOSED EROSION CONTROL MEASURES, SEE PLANS. AREAS DISTURBED BY EROSION BARRIERS SHALL BE LOAMED AND SEEDED, OR OTHERWISE RESTORED TO ORIGINAL CONDITION.

12. THE CONTRACTOR SHALL REMOVE ALL SEDIMENTATION CONTROL SYSTEMS, REMOVE ALL ACCUMULATED SEDIMENTS, AND SEED THE DISTURBED AREAS WHEN THE CONTROL SYSTEMS ARE NO LONGER REQUIRED. THE CONTRACTOR SHALL REQUEST AND RECEIVE PERMISSION FROM THE ENGINEER PRIOR TO REMOVING ANY CONTROL SYSTEM.

13. ALL WORK ASSOCIATED WITH TEMPORARY EROSION CONTROL MEASURES AND ACTIVITIES NOT INCLUDED UNDER A SPECIFIC PAY ITEM SHALL BE CONSIDERED INCIDENTAL TO THE PROJECT.

NOTE:

TOP LOAD LINE

BALLAST LINE

- BOTTOM SEDIMENT

(GALVANIZED CHAIN)

- WATER LEVEL

FLOTATION DEVICE -

GALVANIZED CHAIN


SIDE VIEW


SILT CURTAIN -


ANCHOR BUOY

-ANCHOR DEVICE

NYLON ROPE-

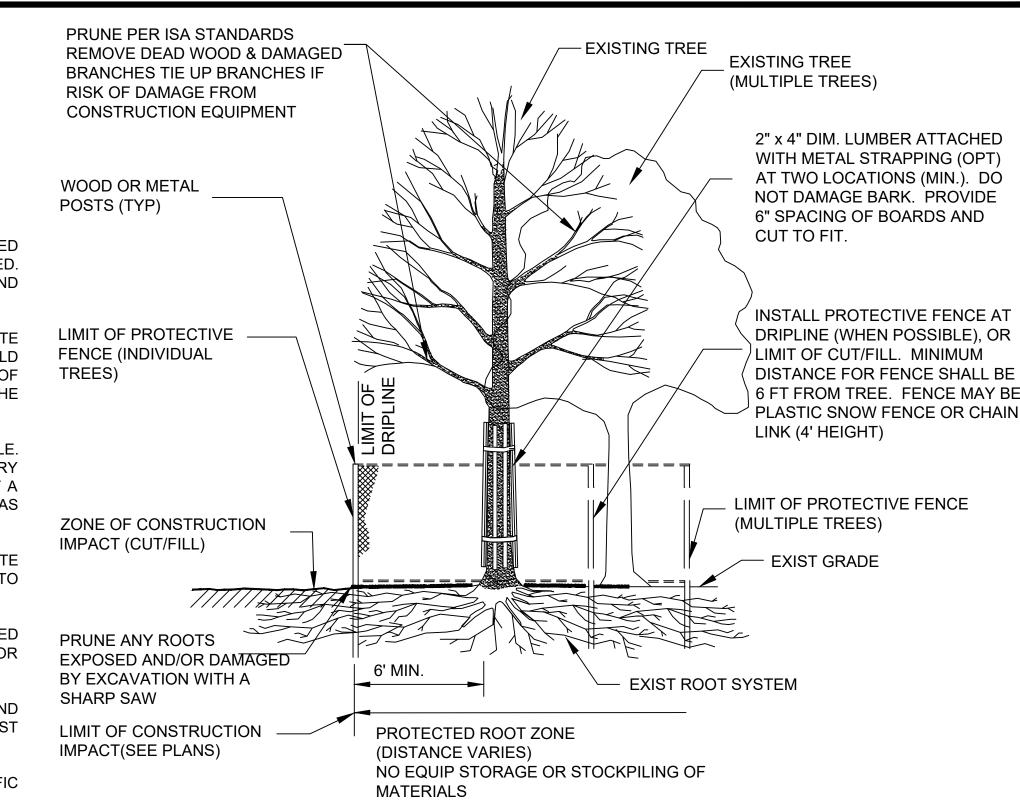

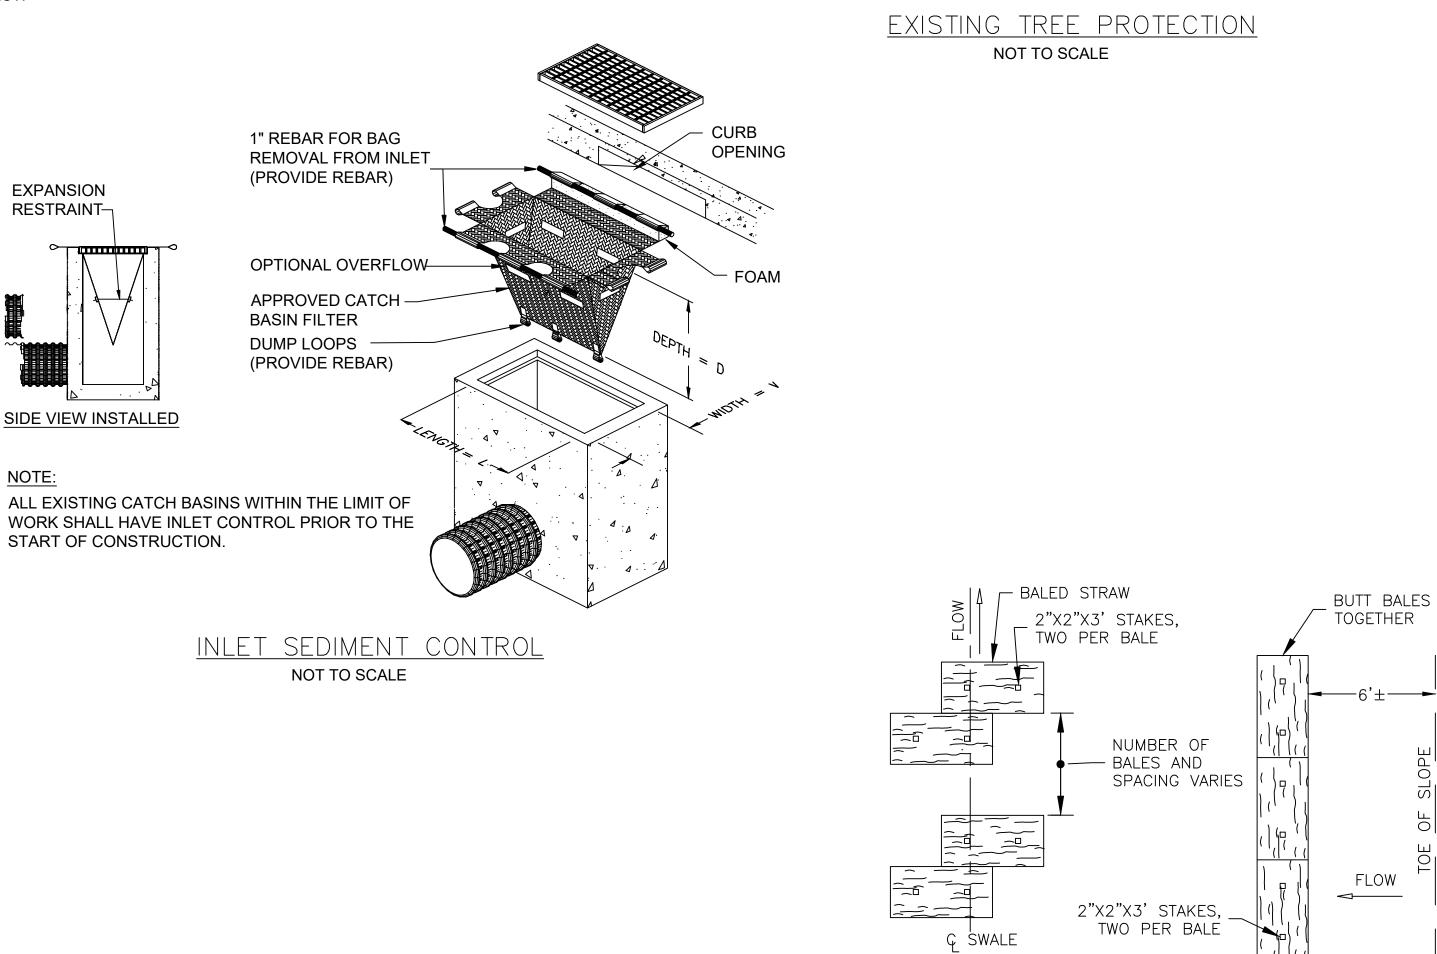


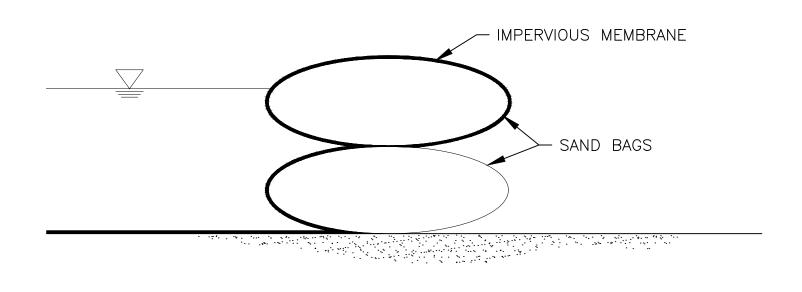


SILT (TURBIDITY) CURTAIN

NOT TO SCALE


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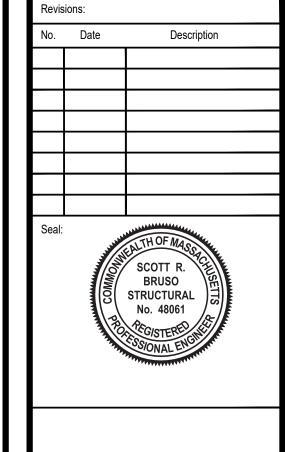


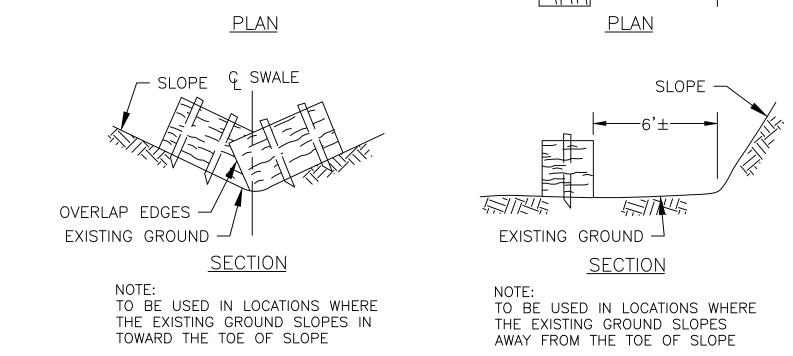STRAW BALES DETAIL N.T.S.

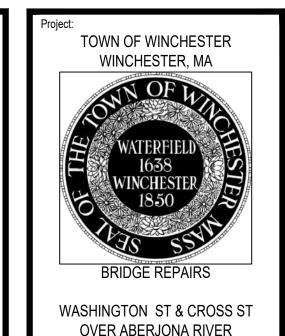

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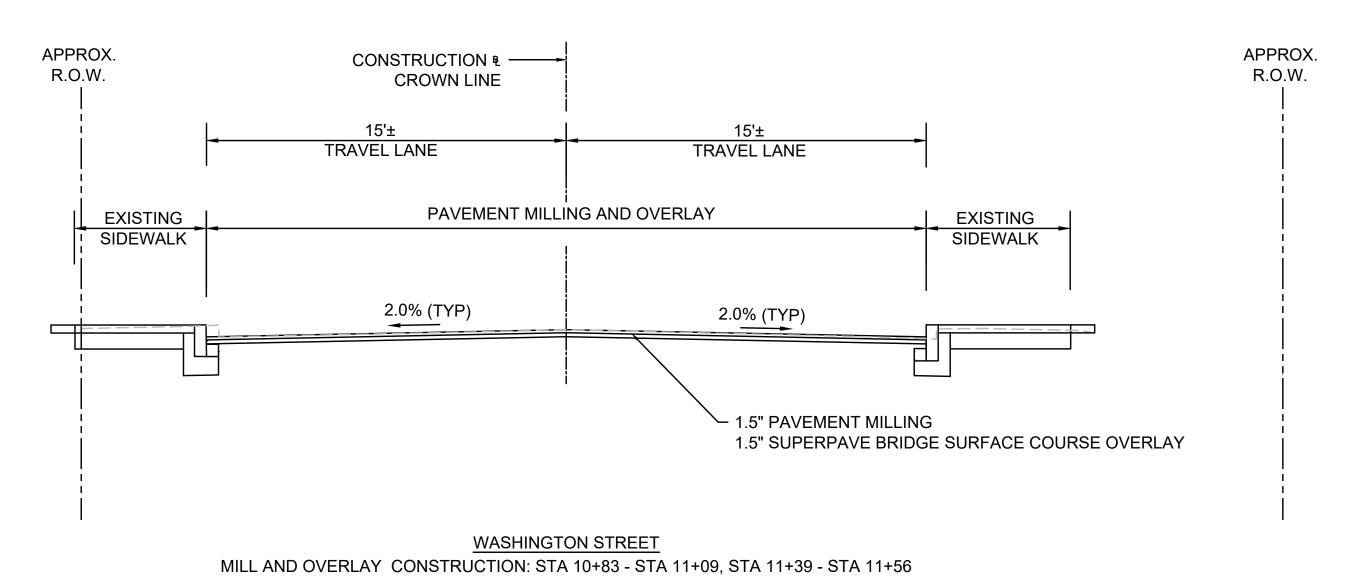


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Drawn By:	SRG
Reviewed By:	KAC
Approved By:	XXX
W&S Project No.: W&S File No.:	ENG21 - 1288

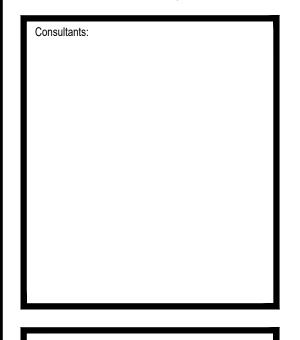E&S DETAILS

Sheet Number:



SCALE: 1"=4'

PAVEMENT NOTES

PAVEMENT MILLING AND OVERLAY:

 $1\frac{1}{2}$ " SUPERPAVE BRIDGE SURFACE COURSE - 9.5 (SSC-B-9.5) OVER ASPHALT EMULSION FOR TACK COAT OVERLAY $1\frac{1}{2}$ " PAVEMENT MICRO MILLING

PROPOSED BRIDGE PAVEMENT:

1.5" SUPERPAVE BRIDGE SURFACE COURSE - 9.5 (SSC-B-9.5) OVER ASPHALT EMULSION FOR TACK COAT OVERLAY OVER 1.5" SUPERPAVE BRIDGE PROTECTIVE COURSE - 9.5 (SPC-9.5) OVER

TOWN OF WINCHESTER WINCHESTER, MA

WATERFIELD

1638
WINCHESTER

1850

BRIDGE REPAIRS

Weston & Sampso


WASHINGTON ST & CROSS ST

OVER ABERJONA RIVER

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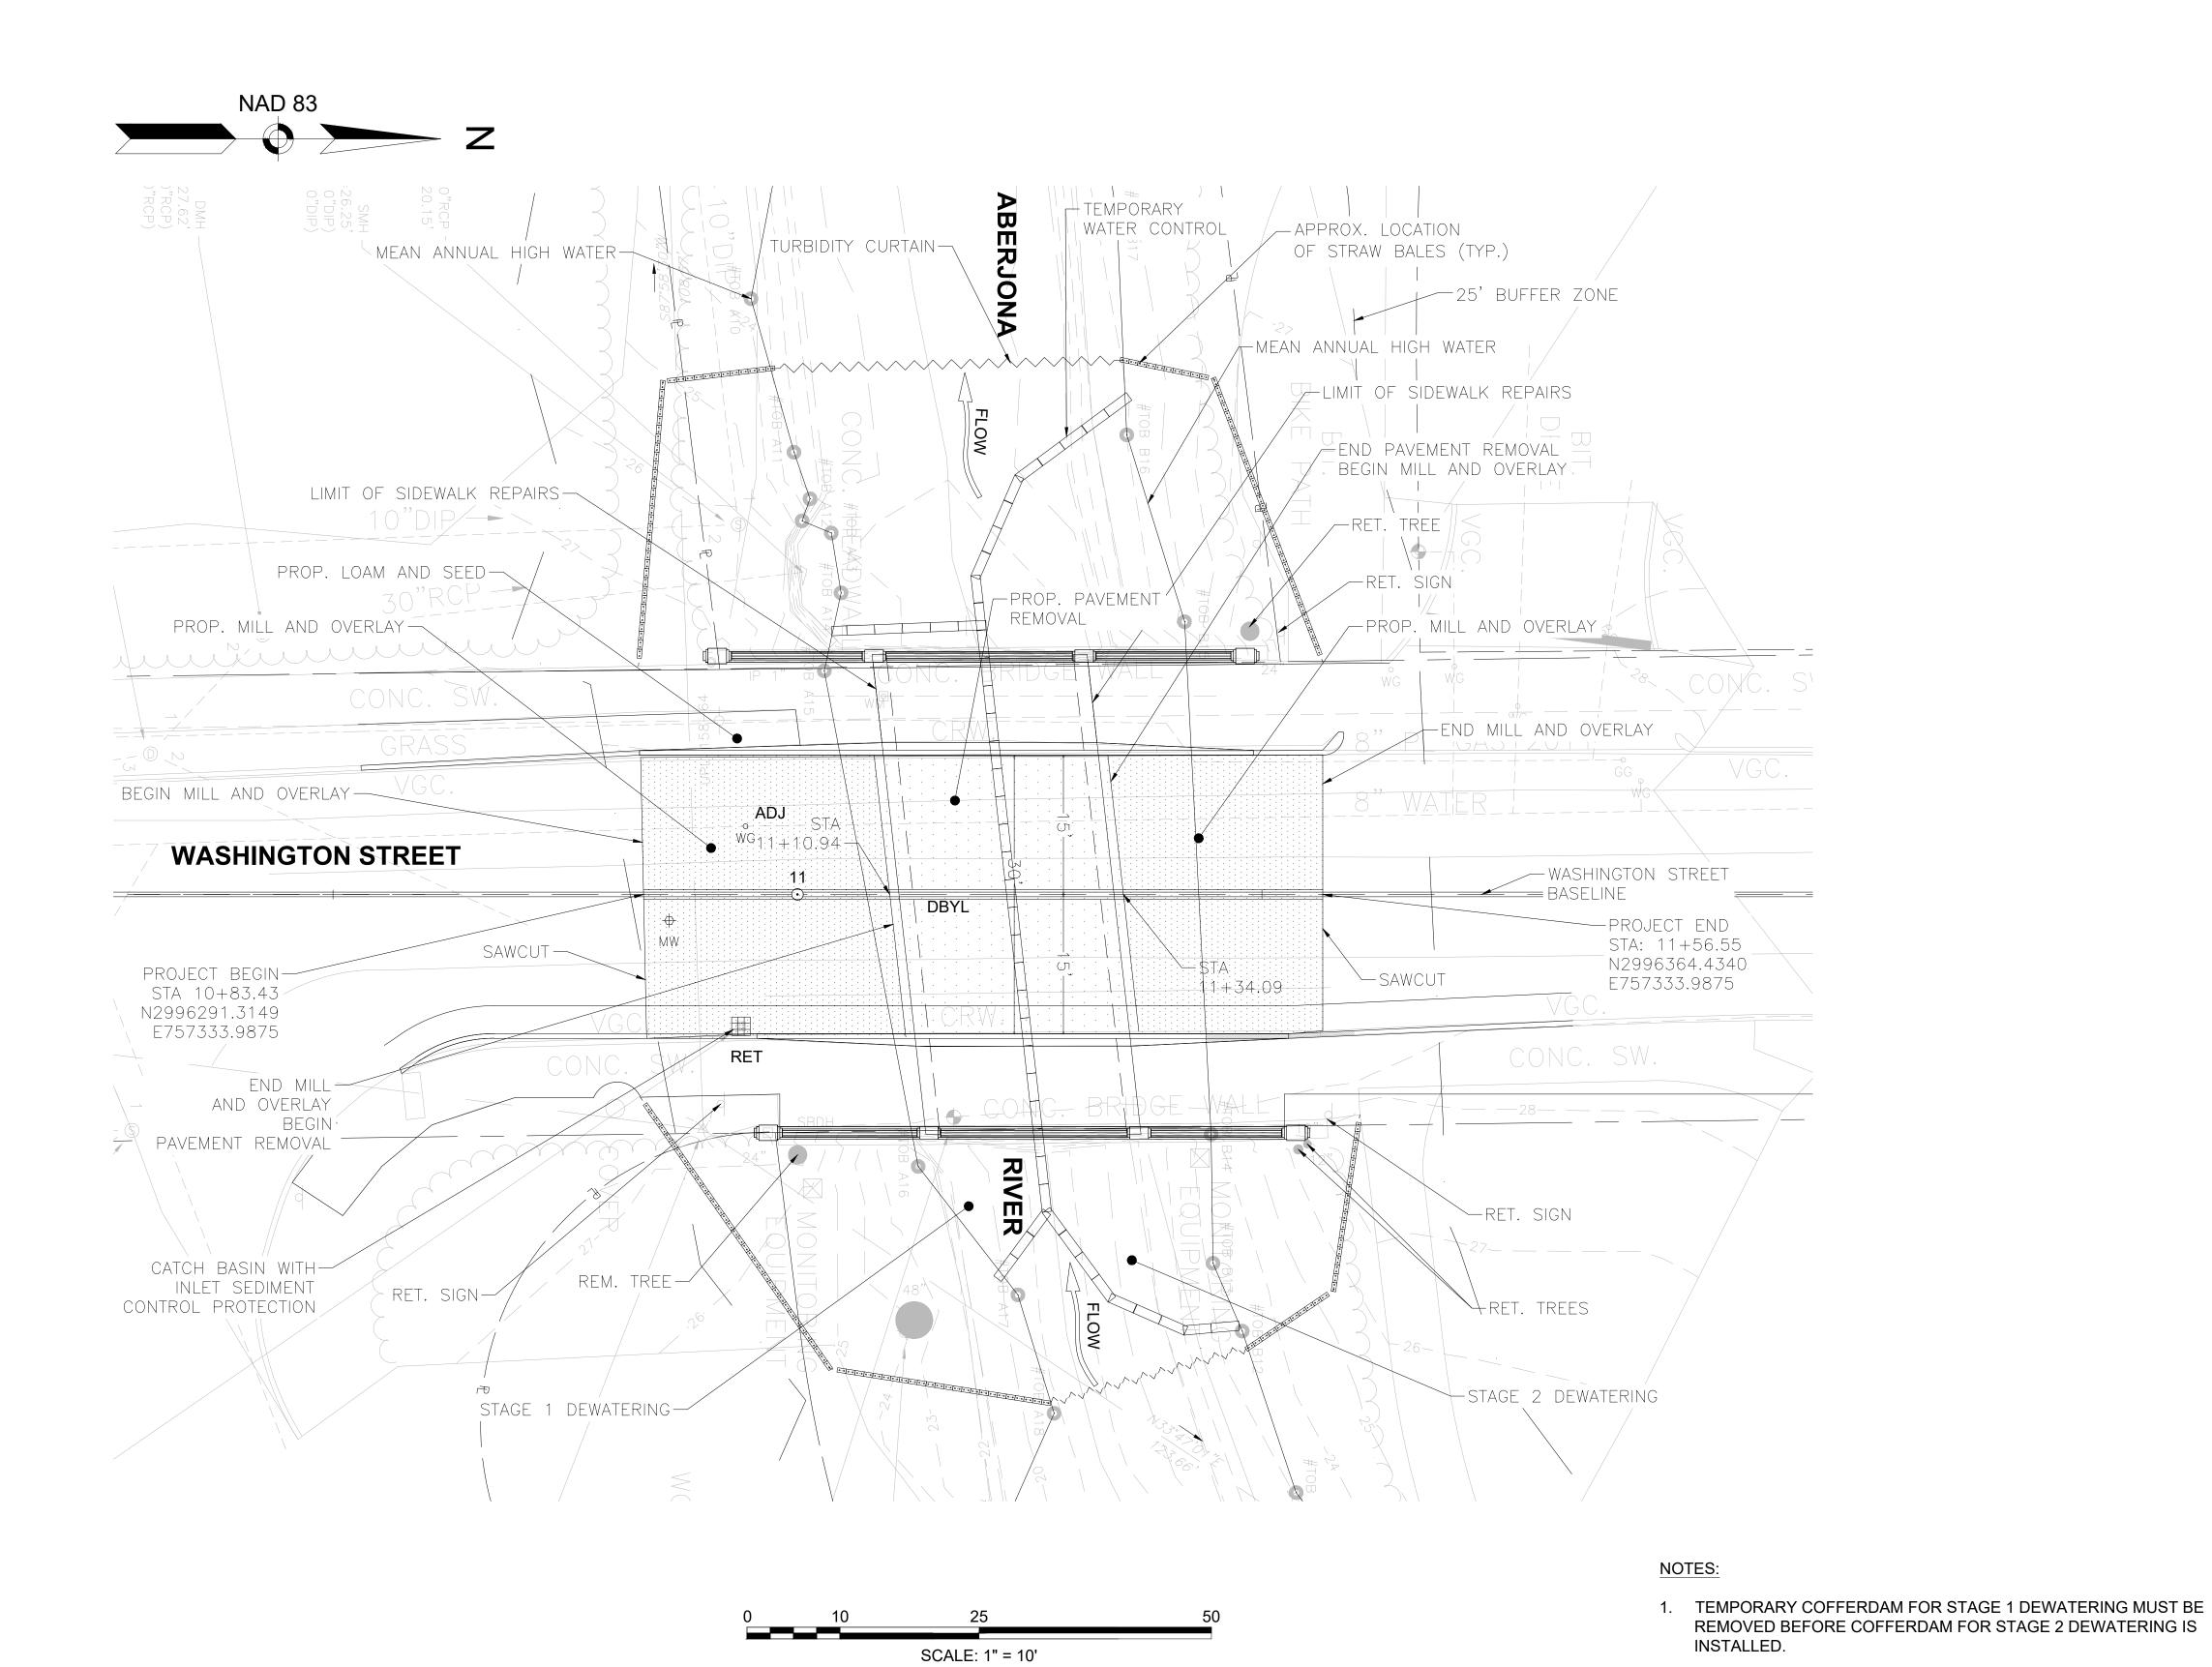
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Reviewed By:	KAC
Approved By:	XXX
W&S Project No.:	ENG21 - 1288
W&S File No.:	

Drawing Title:

TYPICAL SECTIONS

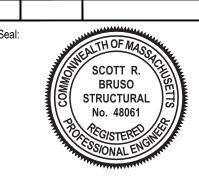Chaat Number

C-3



TOWN OF WINCHESTER WINCHESTER, MA

WATERFIELD

1638
WINCHESTER


1850

BRIDGE REPAIRS


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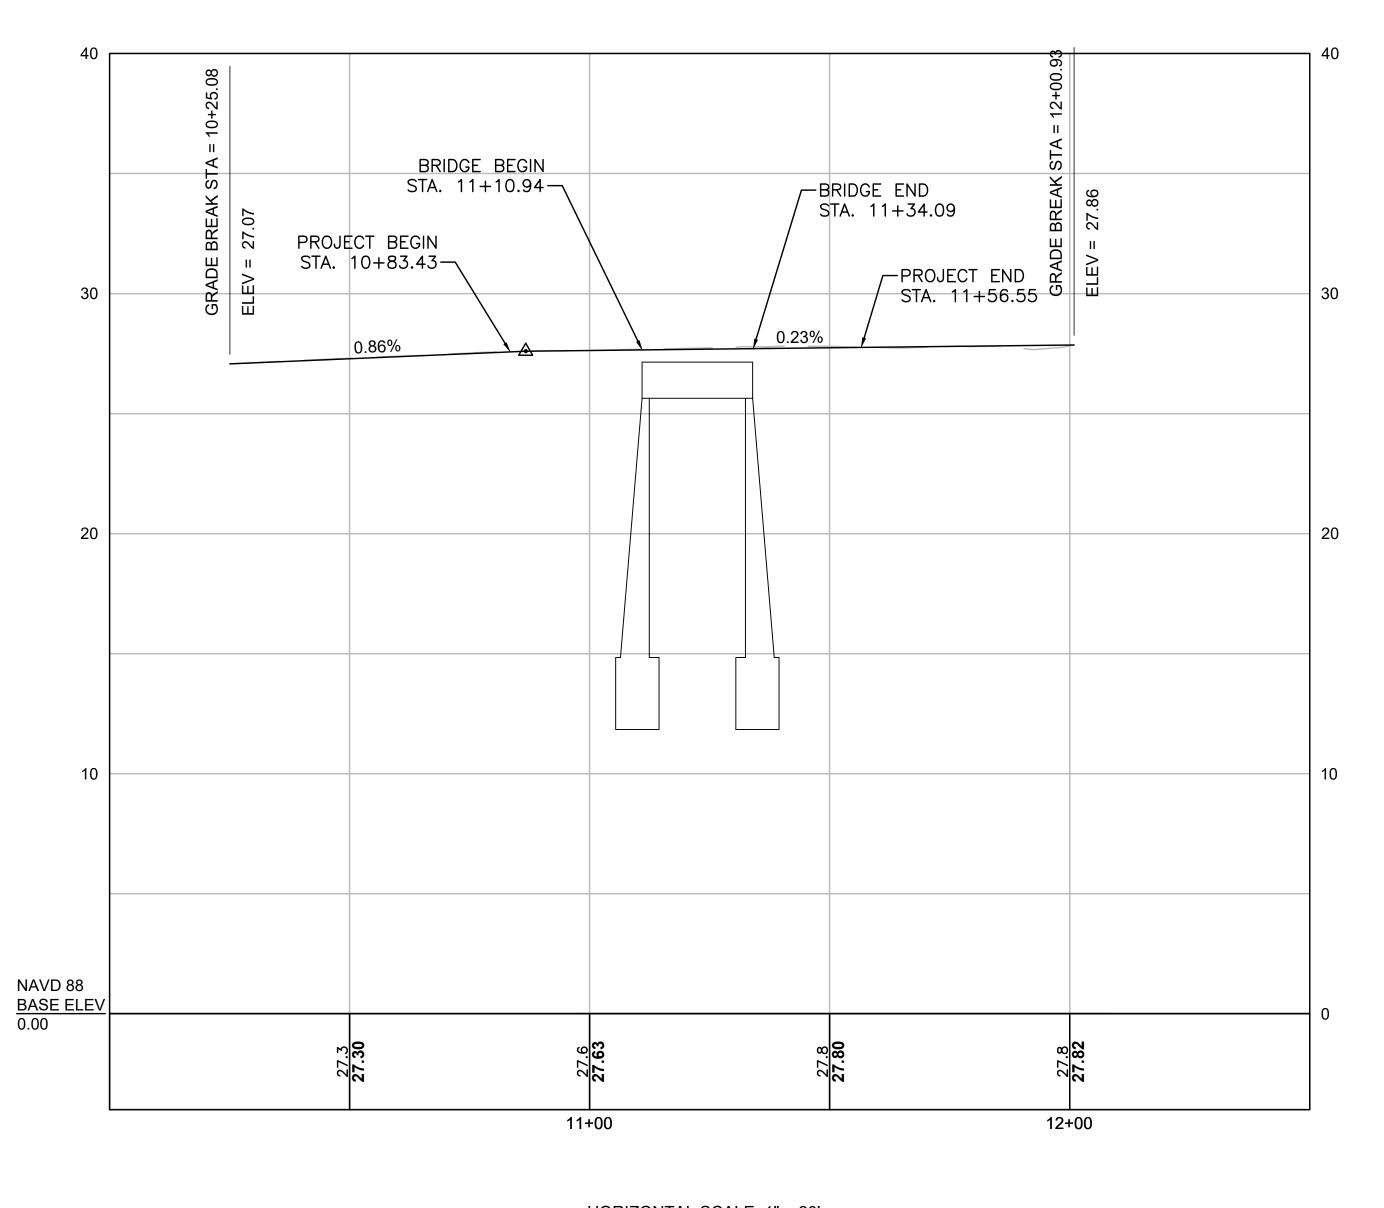
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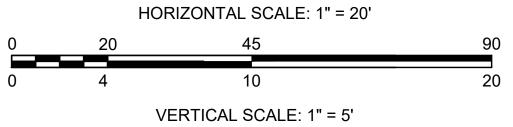
WASHINGTON ST CONSTRUCTION PLAN


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WASHINGTON STREET PROFILE




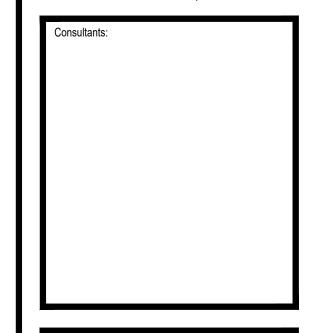

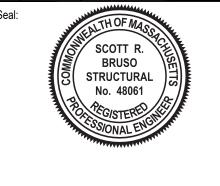


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WASHINGTON ST PLAN & PROFILE

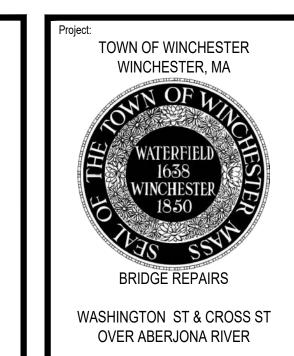
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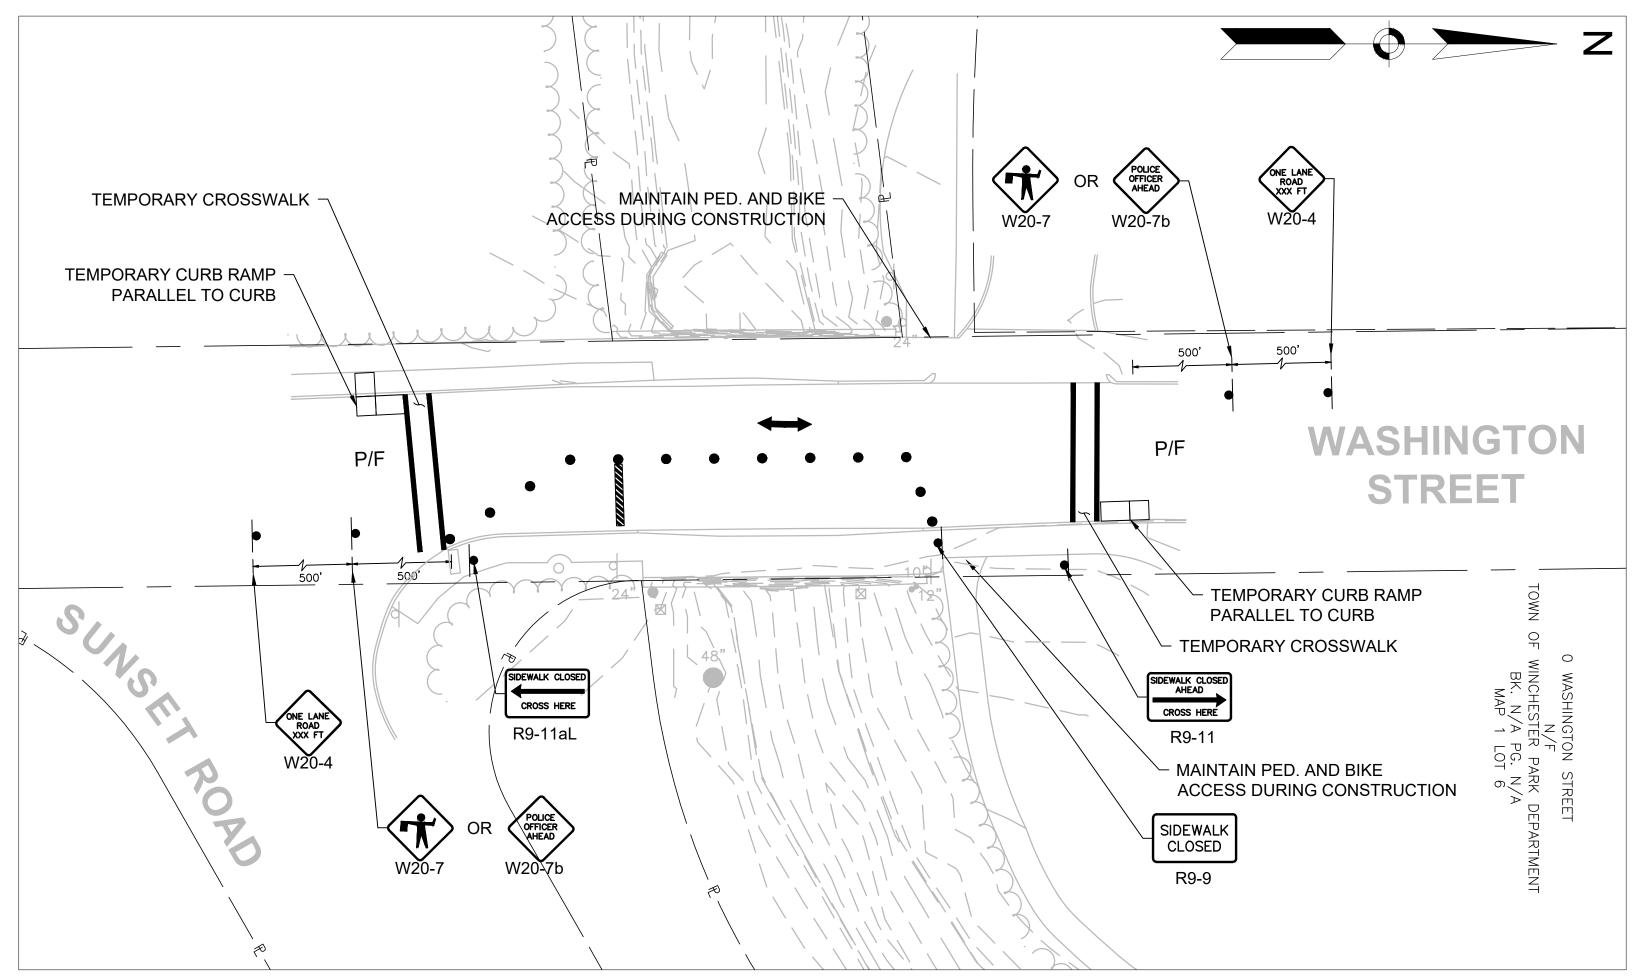
- 1. ALL TEMPORARY TRAFFIC CONTROL WORK SHALL CONFORM TO THE LATEST EDITION OF THE "MANUAL ON UNIFORM TRAFFIC CONTROL DEVICES" (MUTCD) AND ALL REVISIONS, UNLESS SUPERCEDED BY THESE PLANS.
- 2. ALL SIGN LEGENDS, BORDERS, AND MOUNTING SHALL BE IN ACCORDANCE WITH THE MUTCD.
- 3. TEMPORARY CONSTRUCTION SIGNING AND ALL OTHER TRAFFIC CONTROL DEVICES SHALL BE IN PLACE PRIOR TO THE START OF ANY WORK.
- 4. TEMPORARY CONSTRUCTION SIGNING, BARRICADES, AND ALL OTHER NECESSARY WORK ZONE TRAFFIC CONTROL DEVICES SHALL BE REMOVED FROM THE HIGHWAY OR COVERED WHEN THEY ARE NOT REQUIRED FOR CONTROL OF TRAFFIC.
- 5. SIGNS AND SIGN SUPPORTS LOCATED ON OR NEAR THE TRAVELED WAY, CHANNELIZING DEVICES, BARRIERS, AND CRASH ATTENUATORS MUST PASS THE CRITERIA SET FORTH IN NCHRP REPORT 350, "RECOMMENDED PROCEDURES FOR THE SAFETY PERFORMANCE EVALUATION OF HIGHWAY FEATURES" AND/OR "MANUAL FOR ASSESSING SAFETY HARDWARE" (MASH).
- 6. CONTRACTORS SHALL NOTIFY EACH ABUTTER AT LEAST 24 HOURS IN ADVANCE OF THE START OF ANY WORK THAT WILL REQUIRE THE TEMPORARY CLOSURE OF ACCESS, SUCH AS CONDUIT INSTALLATION, EXISTING PAVEMENT EXCAVATION, TEMPORARY DRIVEWAY PAVEMENT PLACEMENT, AND SIMILAR OPERATIONS.
- 7. THE FIRST TEN PLASTIC DRUMS OF A TAPER SHALL BE MOUNTED WITH TYPE A LIGHTS.
- 8. THE ADVISORY SPEED LIMIT, IF REQUIRED, SHALL BE DETERMINED BY THE ENGINEER.
- 9. DISTANCES ARE A GUIDE AND MAY BE ADJUSTED IN THE FIELD BY THE ENGINEER.
- 10. MAXIMUM SPACING OF TRAFFIC DEVICES IN A TAPER (DRUMS OR CONES) IS EQUAL IN FEET TO THE SPEED LIMIT IN MPH.
- 11. MINIMUM LANE WIDTH IS TO BE 11 FEET UNLESS OTHERWISE SHOWN. MINIMUM LANE WIDTH TO BE MEASURED FROM THE EDGE OF DRUMS OR MEDIAN BARRIER.
- 12. PEDESTRIANS SHALL BE PROVIDED WITH ACCESS AND SAFE PASSAGE THROUGH THE TEMPORARY TRAFFIC CONTROL ZONE AT ALL TIMES.
- 13. NO DIFFERENCE IN ROADWAY LANE ELEVATION WILL BE ALLOWED AT THE END OF THE WORK DAY.
- 14. DASHED LINES SHOW LANE DESIGNATIONS TO BE USED DURING CONSTRUCTION.
- 15. THE CONTRACTOR SHALL SUBMIT ANY REVISIONS TO THE CONSTRUCTION ZONE SAFETY PLAN TO THE ENGINEER APPROVAL.
- 16. THIS CONSTRUCTION ZONE SAFETY PLAN SHALL NOT RELIEVE THE CONTRACTOR OF HIS SOLE RESPONSIBILITY FOR CONSTRUCTION SITE SAFETY.
- 17. ACCESS TO WASHINGTON STREET AND SUNSET ROAD SHALL BE MAINTAINED ALL THE TIMES DURING CONSTRUCTION.

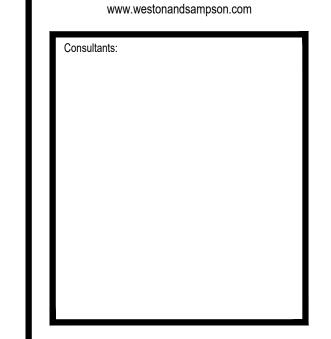LEGEND:

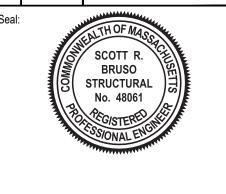


TEMPORARY TRAFFIC SIGN SUMMARY

MUTCD	SIZE OF SIGN		01011	OT) (COLOR		
CODE	WIDTH	HEIGHT	SIGN	QTY	BACK- GROUND	LEGEND	BORDER
W20-4	36"	36"	ONE LANE ROAD 1000 FT	2	FLUOR- ESCENT ORANGE	BLACK	BLACK
MA-W20-7b	36"	36"	POLICE OFFICER AHEAD	2	FLUOR- ESCENT ORANGE	BLACK	BLACK
W20-7	36"	36"	(i)	2	FLUOR- ESCENT ORANGE	BLACK	BLACK
R9-9	24"	12"	SIDEWALK CLOSED	1	WHITE	BLACK	BLACK
R9-11R	24"	18"	CROSS HERE	1	WHITE	BLACK	BLACK
R9-11L	24"	18"	SIDEWALK CLOSED CROSS HERE	1	WHITE	BLACK	BLACK

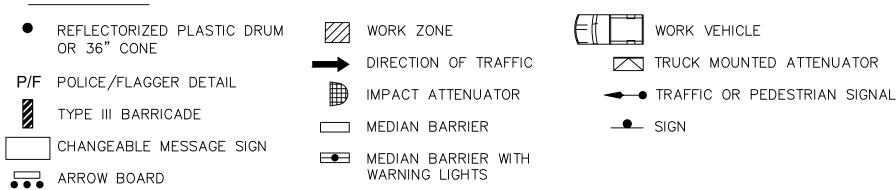


TEMPORARY TRAFFIC CONTROL PLAN - EAST SIDE SCALE: 1" = 20'

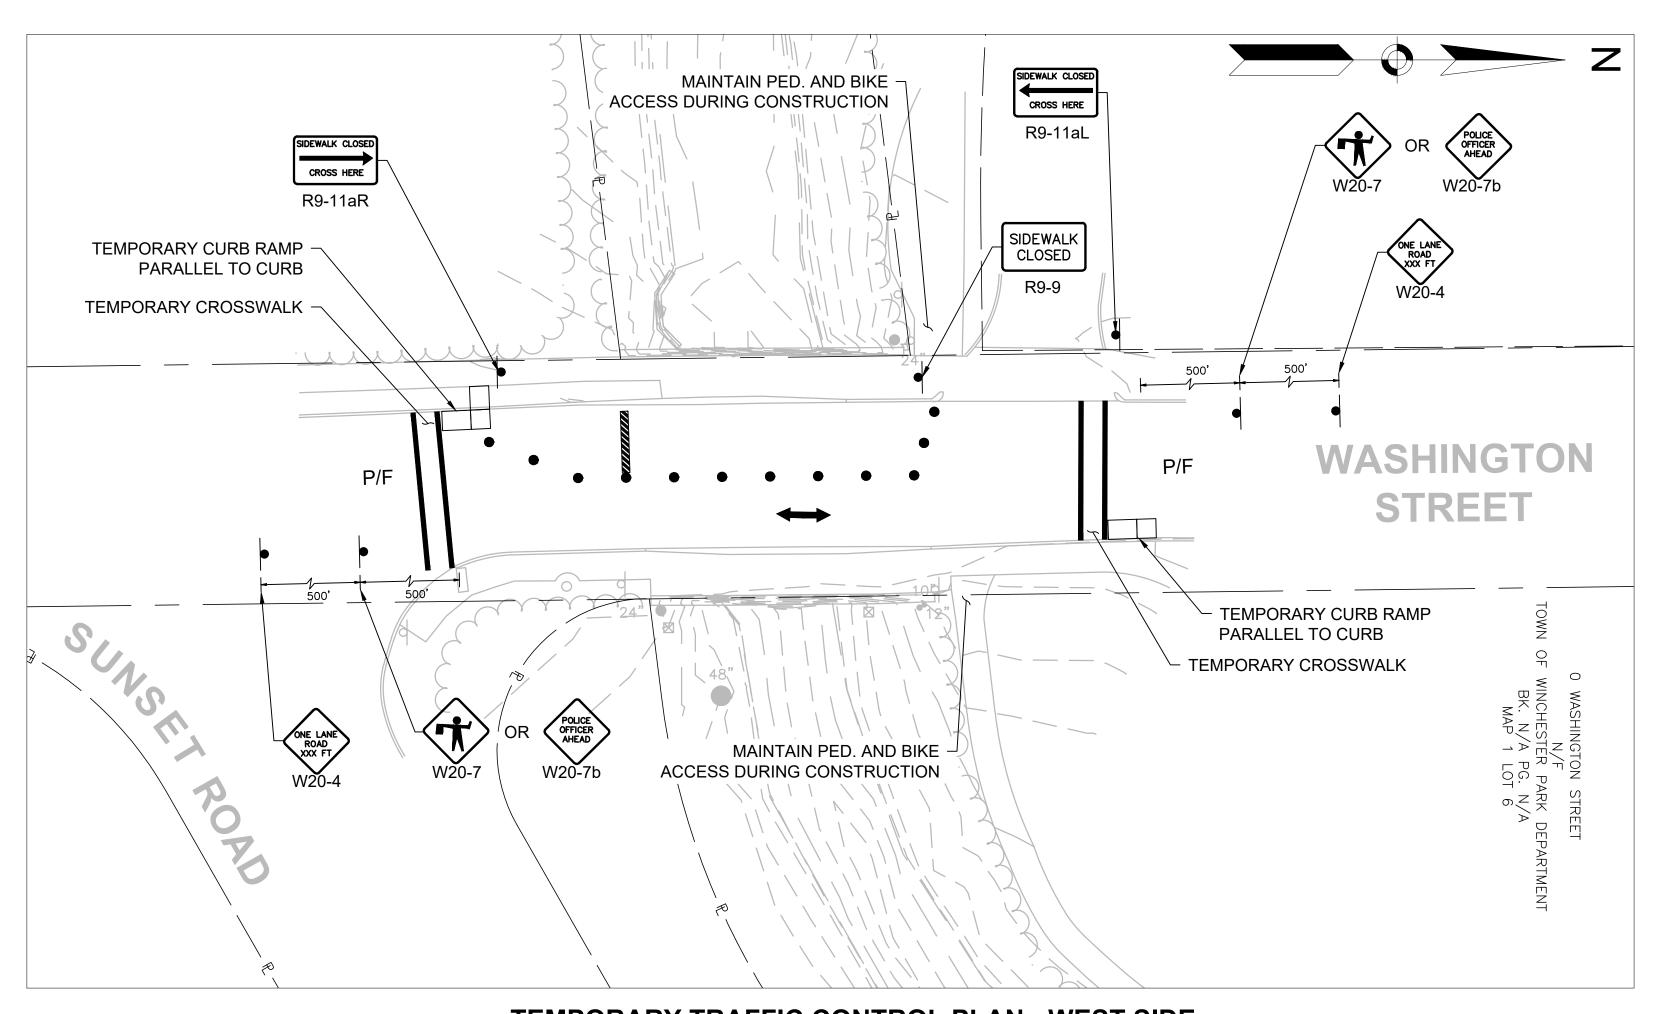

TEMPORARY TRAFFIC CONTROL PLAN - WEST SIDE

SCALE: 1" = 20'

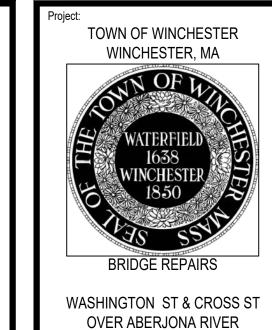

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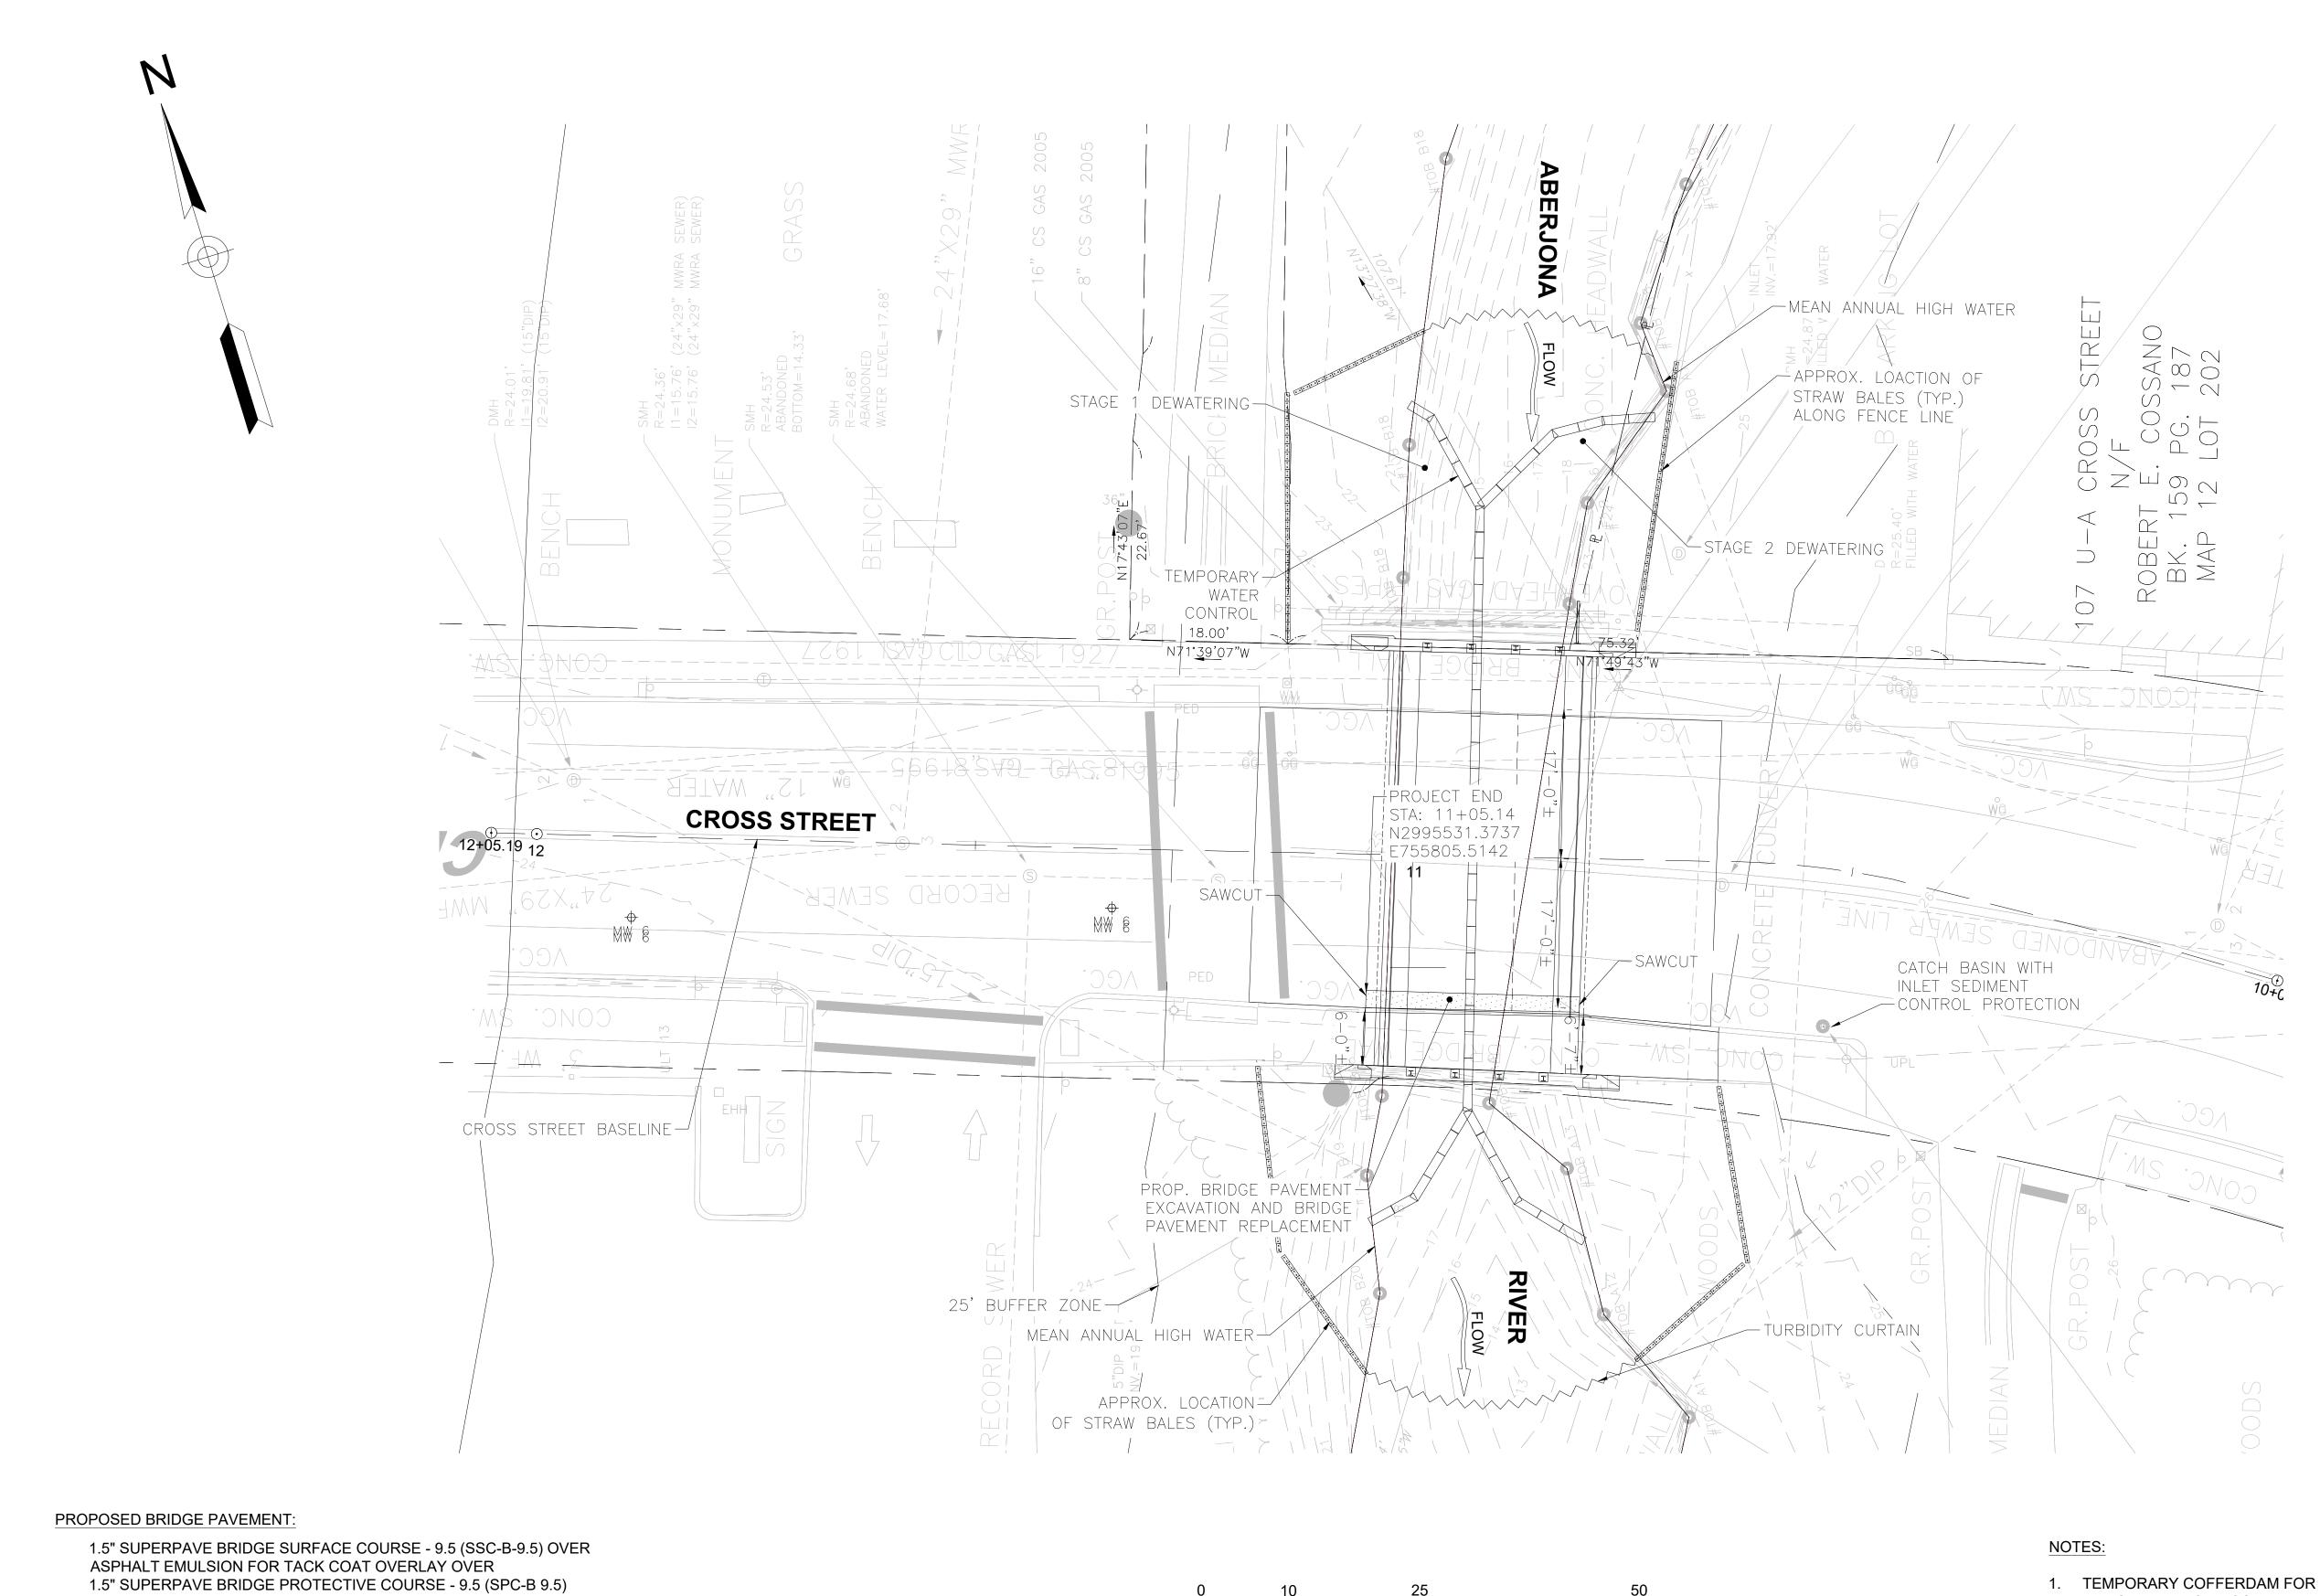
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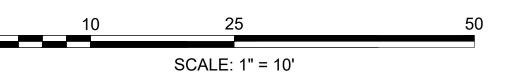
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WASHINGTON STREET TEMPORARY TRAFFIC CONTROL PLAN


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 TEMPORARY COFFERDAM FOR STAGE 1 DEWATERING MUST BE REMOVED BEFORE COFFERDAM FOR STAGE 2 DEWATERING IS INSTALLED.




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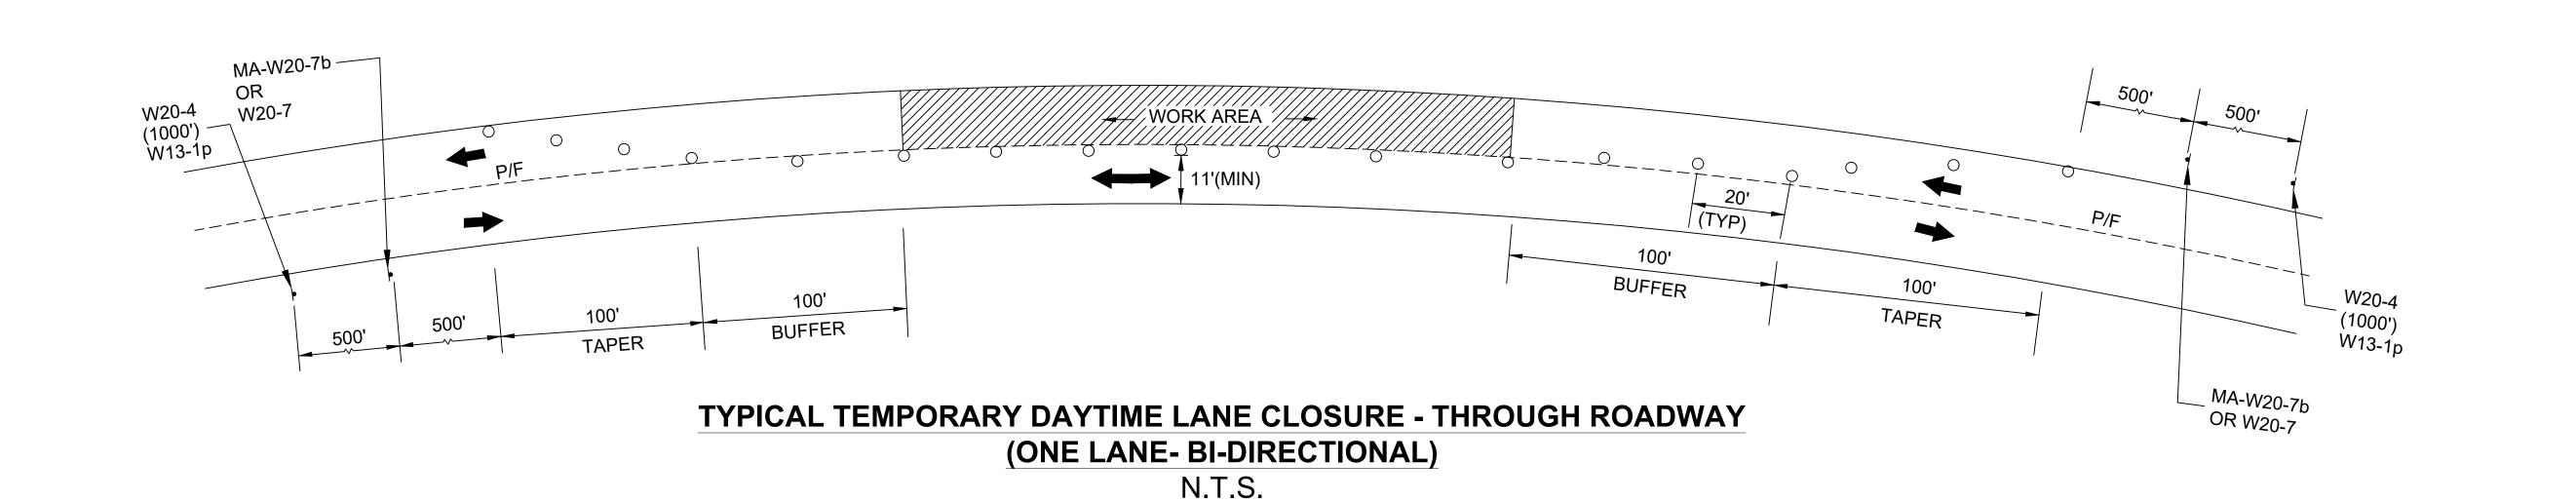
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CROSS ST CONSTRUCTION PLAN

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TEMPORARY CROSSWALK


TEMPORARY CROSSWALK

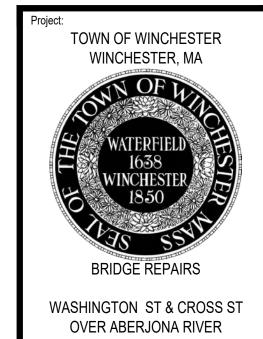ACCESS DURING CONSTRUCTION

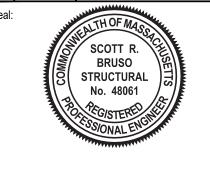NOTES:


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- 13. NO DIFFERENCE IN ROADWAY LANE ELEVATION WILL BE ALLOWED AT THE END OF THE WORK
- 14. DASHED LINES SHOW LANE DESIGNATIONS TO BE USED DURING CONSTRUCTION.
- 15. THE CONTRACTOR SHALL SUBMIT ANY REVISIONS TO THE CONSTRUCTION ZONE SAFETY PLAN TO THE ENGINEER APPROVAL.
- 16. THIS CONSTRUCTION ZONE SAFETY PLAN SHALL NOT RELIEVE THE CONTRACTOR OF HIS SOLE RESPONSIBILITY FOR CONSTRUCTION SITE SAFETY.
- 17. ACCESS TO CROSS STREET SHALL BE MAINTAINED ALL THE TIMES DURING CONSTRUCTION.

LEGEND:

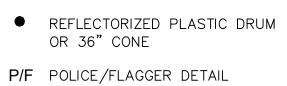

TYPE III BARRICADE

CHANGEABLE MESSAGE SIGN ARROW BOARD

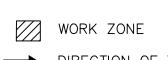

DIRECTION OF TRAFFIC

IMPACT ATTENUATOR MEDIAN BARRIER

■ MEDIAN BARRIER WITH

WARNING LIGHTS

WORK VEHICLE

TRUCK MOUNTED ATTENUATOR

→ TRAFFIC OR PEDESTRIAN SIGNAL

- SIGN

TEMPORARY TRAFFIC SIGN SUMMARY

MUTCD	SIZE C	F SIGN	CICN CTV -		COLOR		
CODE	WIDTH	HEIGHT	SIGN	QTY	BACK- GROUND	LEGEND	BORDER
W20-4	36"	36"	ONE LANE ROAD 1000 FT	3	FLUOR- ESCENT ORANGE	BLACK	BLACK
MA-W20-	7b 36"	36"	POLICE OFFICER AHEAD	3	FLUOR- ESCENT ORANGE	BLACK	BLACK
W20-7	36"	36"	(i)	3	FLUOR- ESCENT ORANGE	BLACK	BLACK
R9-11R	24"	18"	CROSS HERE	1	WHITE	BLACK	BLACK
R9-11L	24"	18"	SIDEWALK CLOSED CROSS HERE	1	WHITE	BLACK	BLACK


TEMPORARY TRAFFIC CONTROL PLAN SCALE: 1" = 20'

CROSS HERE

TOWN OF WINCHESTER WINCHESTER, MA WASHINGTON ST & CROSS ST OVER ABERJONA RIVER


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ONE LANE ROAD XXX FT W20-4

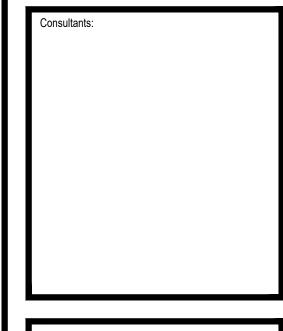


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Approved By:	XXX
W&S Project No.: W&S File No.:	ENG21 - 1288

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CROSS ST TEMPORARY TRAFFIC CONTROL PLAN

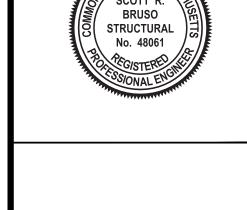

GENERAL NOTES

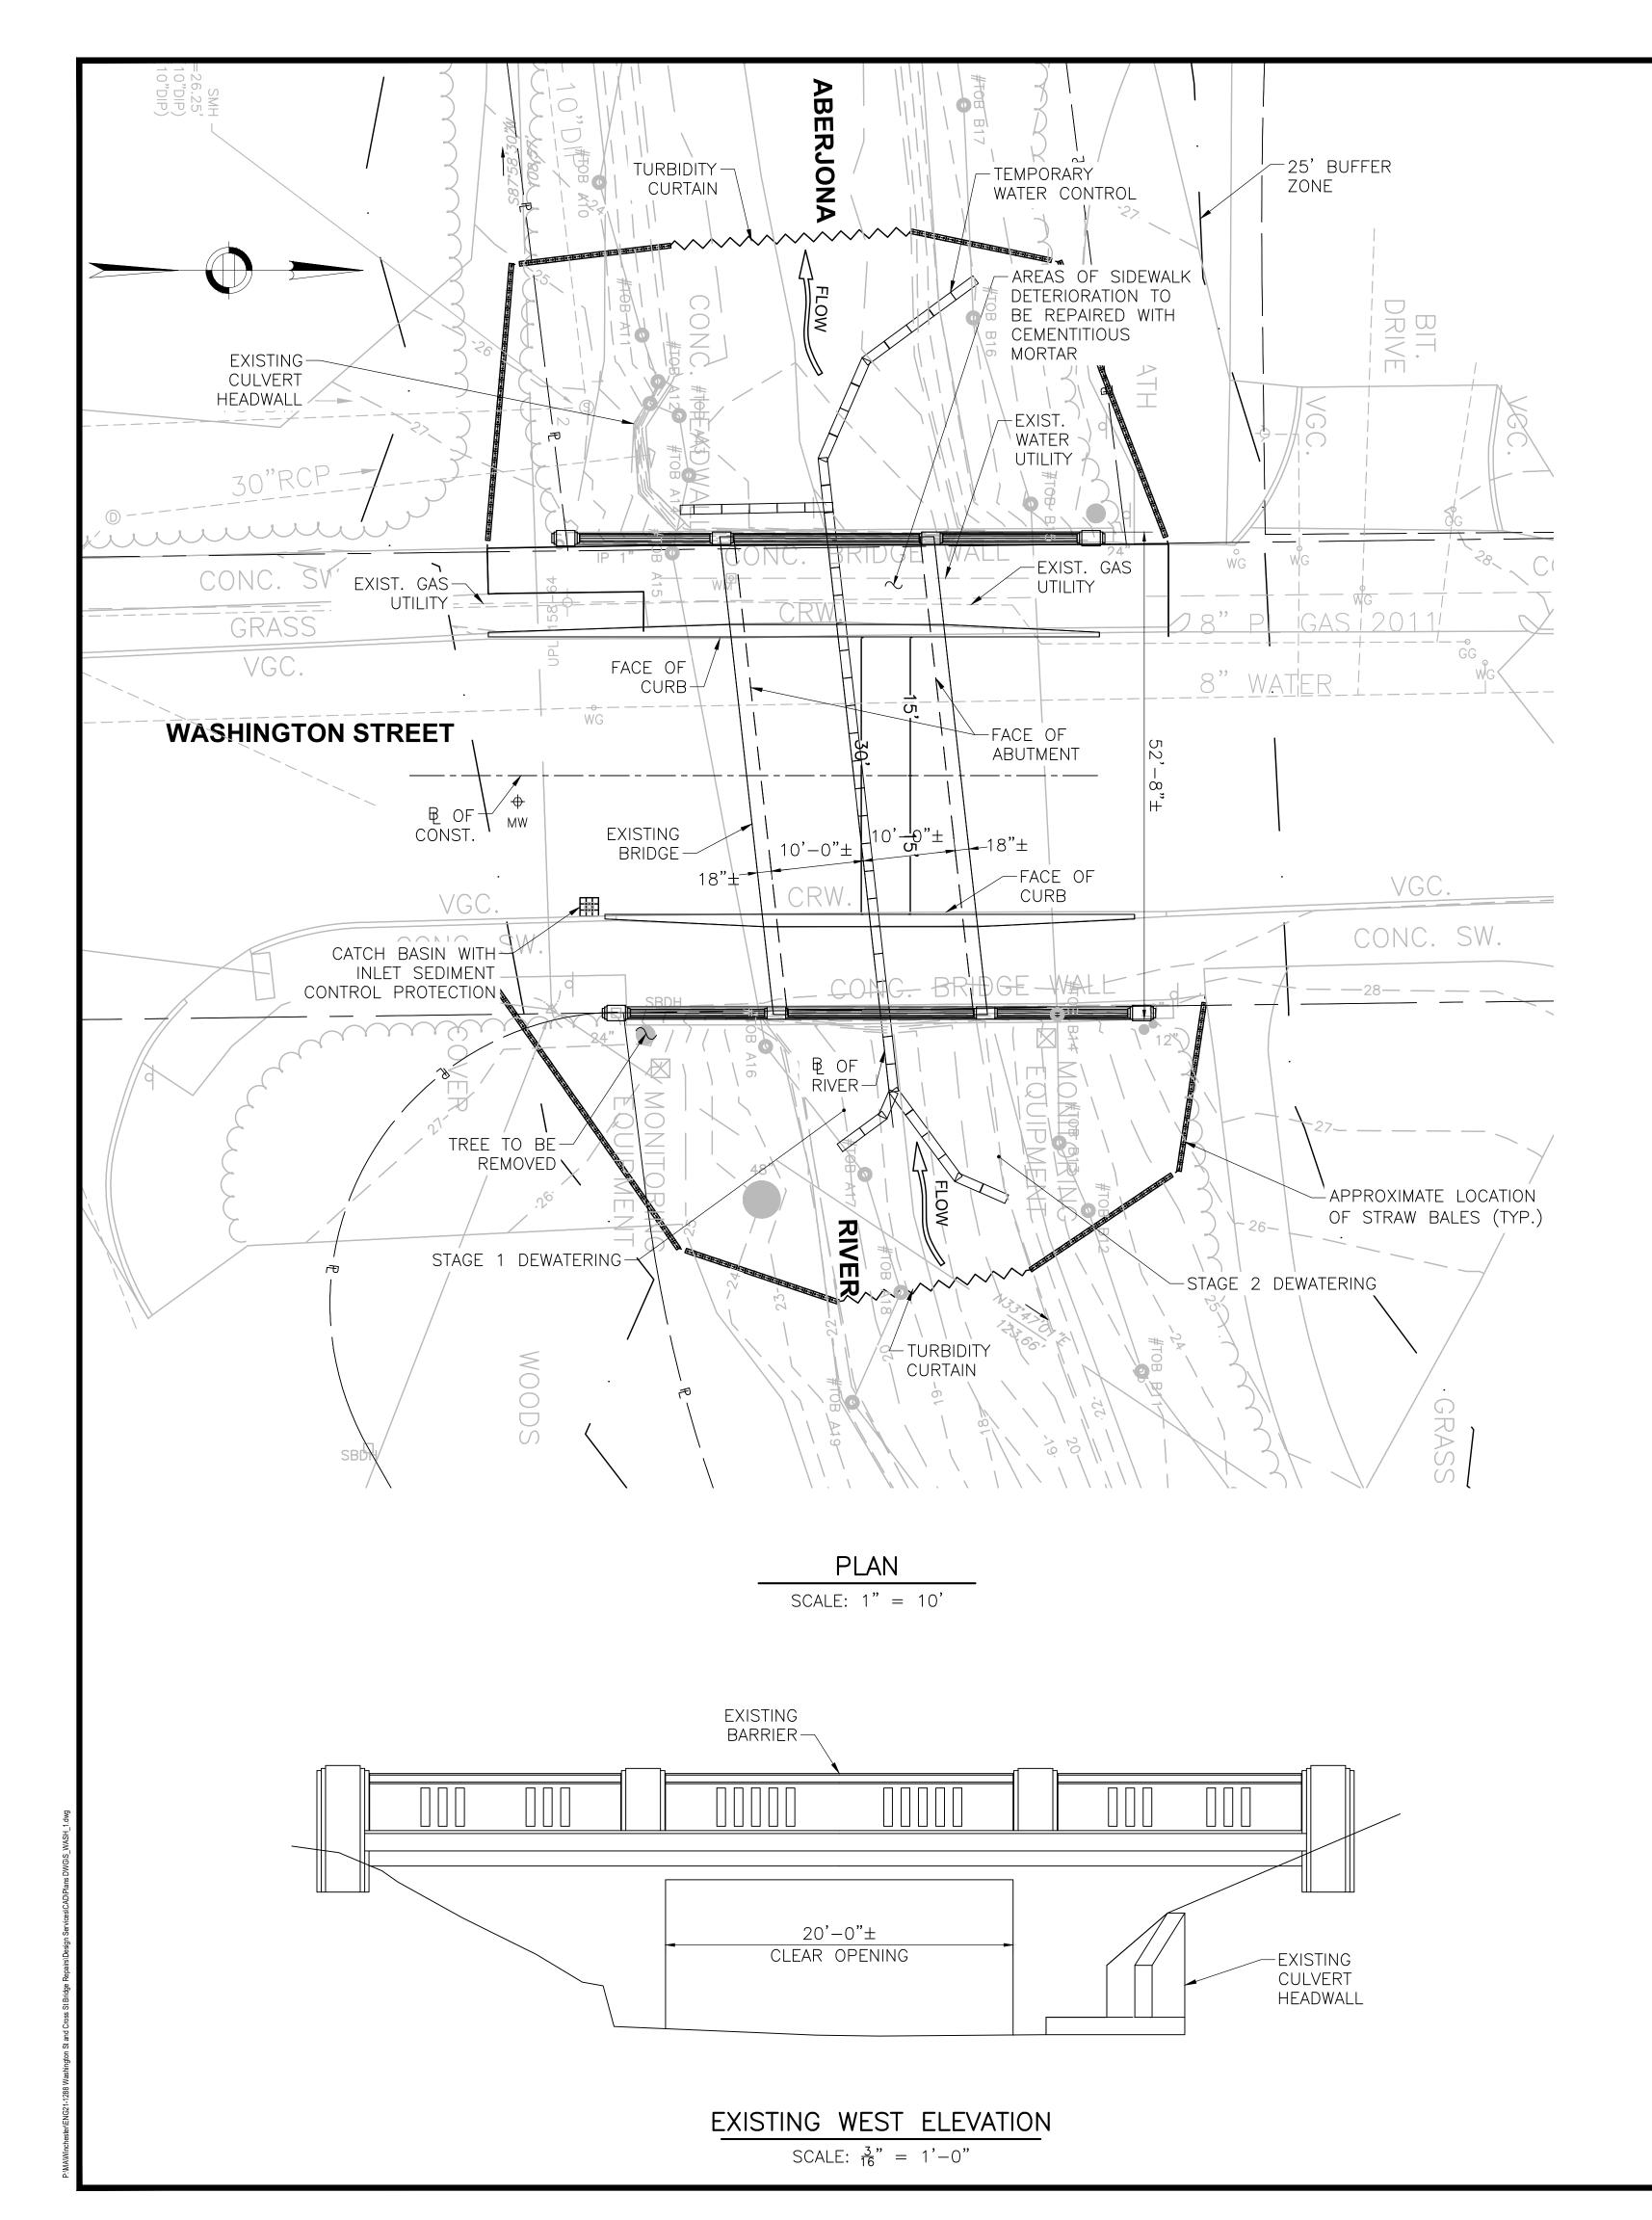EXISTING CONDITIONS:

DIMENSIONS SHOWN AND DETAILS DEPICTED ARE NOT GUARANTEED. THE CONTRACTOR SHALL DETERMINE AND ESTABLISH ALL DIMENSIONS AND DETAILS NECESSARY FOR COMPLETION OF ALL WORK BY FIELD MEASUREMENT AND SURVEY. THE CONCTRACTOR SHALL BE RESPONSIBLE AND NOT ORDER ANY MATERIAL OR COMMENCE ANY FABRICATION UNTIL THE REQUIRED MEASUREMENTS ON THE EXTENT OF THE PROPOSED WORK HAS BEEN APPROVED BY THE ENGINEER.

EXISTING PLANS:

IF REQUIRED, ORIGINAL PLANS FOR THE EXISTING BRIDGE, DATED 1934 MAY BE SEEN AT THE OFFICE OF THE BRIDGE ENGINEER, MASSDOT — HIGHWAY DIVISION. 10 PARK PLAZA, BOSTON, MASSACHUSETTS.

CONCRETE:

ALL CEMENT CONCRETE SHALL BE AS SPECIFIED BELOW: 4000 PSI, \(\frac{3}{4}\)" 585 HP CEMENT CONCRETE

REINFORCEMENT:

REINFORCING STEEL SHALL CONFORM TO THE REQUIREMENTS OF AASHTO M31 GRADE 60. UNLESS OTHERWISE NOTED ON THE CONSTRUCTION DRAWINGS, ALL BARS SHALL BE LAPPED AS FOLLOWS:

MOD	DIFICATION CONDITION	<u>#4 BARS</u>	#5BARS	#6BARS
1.	NONE	16"	19"	23"
2.	12" OF CONCRETE BELOW BAR	20"	25"	30"
3.	COATED BARS, COVER < 3d _b , OR	23"	29"	34"
	CLEAR SPACING < 6db			
4.	COATED BARS, ALL OTHER CASES	18"	23"	27"
5.	CONDITION 2. AND 3.	26"	32"	39"
6.	CONDITION 2. AND 4.	24"	30"	36"

ALL OTHER BARS SHALL BE LAPPED AS SHOWN ON THE CONSTRUCTION DRAWINGS.

FIELD SURVEY:


PRIOR TO COMMENCEMENT OF ANY REPAIR WORK, THE CONTRACTOR SHALL PERFORM FIELD SURVEY TO DETERMINE AND MARK OUT THE EXTENTS OF ALL DETERIORATION AND REPAIRS TO BE PERFORMED. FIELD SURVEY SHALL INCLUDE SOUNDING FOR DELAMINATION AND KNOCKING OFF LOOSE CONCRETE VIA HAMMER TAPPING. THE CONTRACTOR MUST THEN RECIEVE APPROVAL OF ALL DETERIORATION AND REPAIR EXTENTS BY THE ENGINEER PRIOR TO THE COMMENCEMENT OF REPAIR WORK. THE ENGINEER SHALL HAVE FINAL SAY ON ALL LIMITS OF DETERIORATION AND REPAIRS.

NETTING/SHIELDING:

THE CONTRACTOR SHALL PROVIDE NETTING OR SHIELDING BENEATH THE REPAIR LOCATIONS TO PROTECT THE RIVER FROM FALLING CONSTRUCTION MATERIALS

TEMPORARY WATER CONTROL:

COFFERDAM FOR STAGE 1 DEWATERING MUST BE REMOVED BEFORE COFFERDAM FOR STAGE 2 DEWATERING IS INSTALLED.

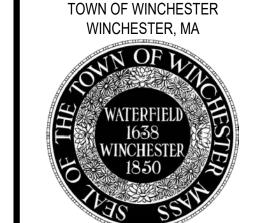


WASHINGTON ST & CROSS ST OVER ABERJONA RIVER

BRIDGE REPAIRS

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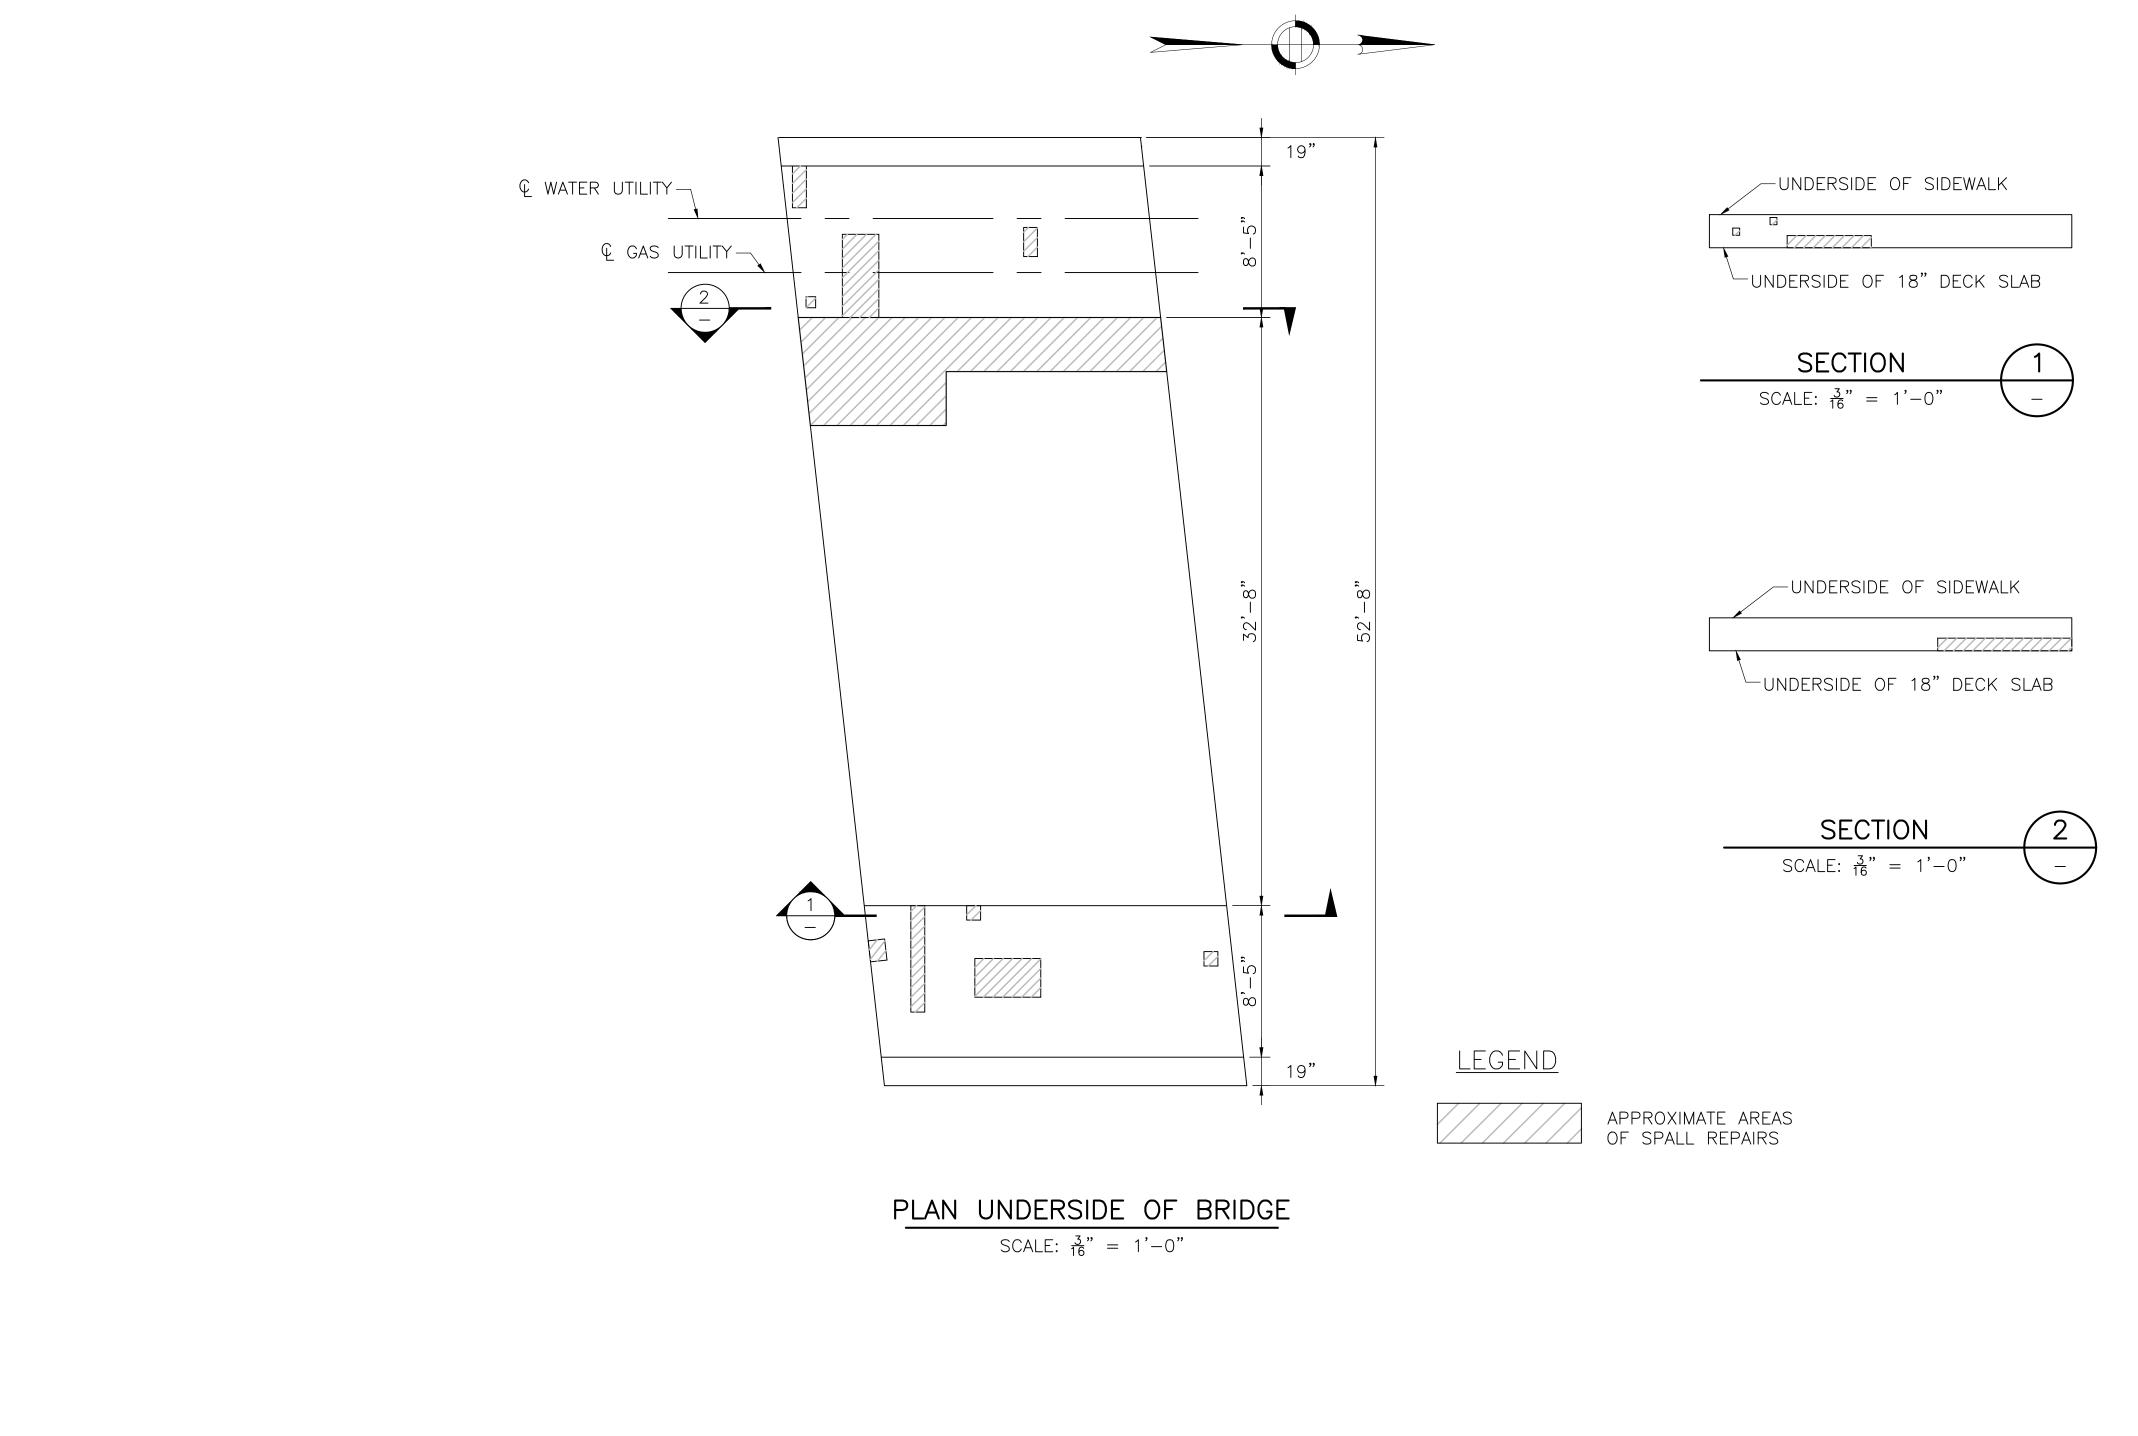
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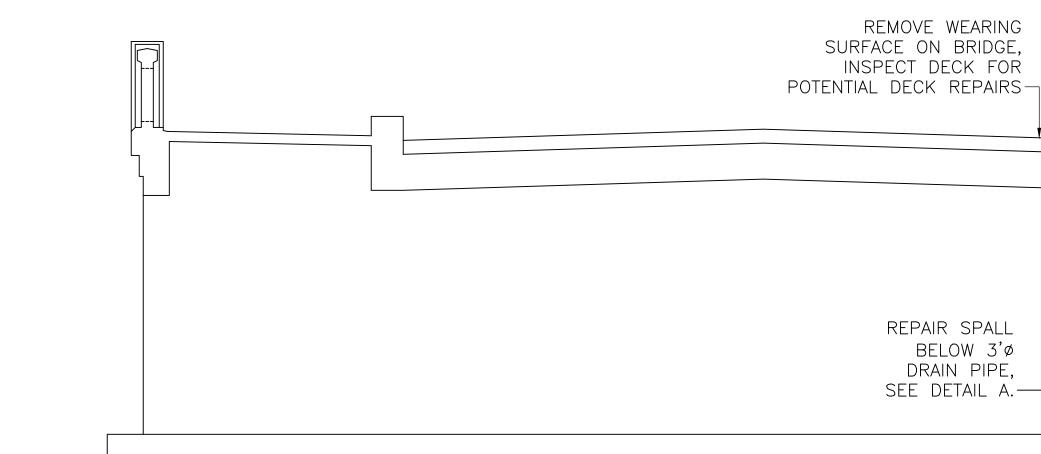
WASHINGTON ST PLAN AND ELEVATION

Sheet Number:
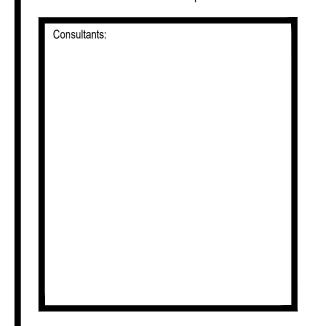
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REPAIR CRACK WITH EPOXY INJECTION



NORTH ABUTMENT ELEVATION

REMOVE WEARING SURFACE ON BRIDGE, INSPECT DECK FOR POTENTIAL DECK REPAIRS—

REPAIR CRACK WITH

EPOXY INJECTION—

∠GAS UTILITY

∠ WATER


UTILITY

SCALE: $\frac{1}{4}$ " = 1'-0"

SOUTH ABUTMENT ELEVATION SCALE: $\frac{1}{4}$ " = 1'-0"

GAS UTILITY


WATER \ UTILITY \

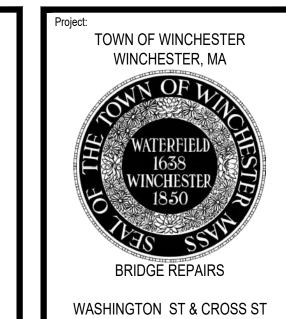

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OVER ABERJONA RIVER

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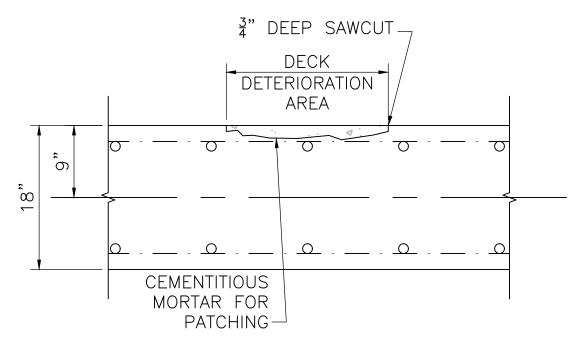


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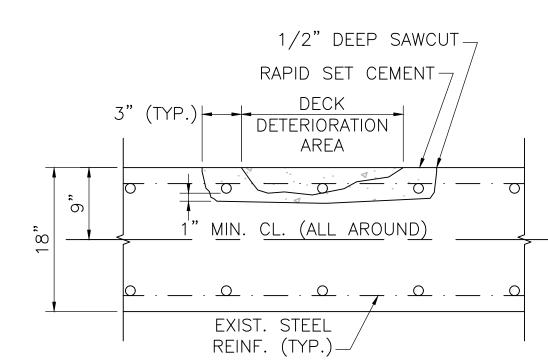
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Date:	06/07/2023
Drawn By:	YS
Reviewed By:	XXX
Approved By:	XXX
W&S Project No.:	ENG21 - 1288

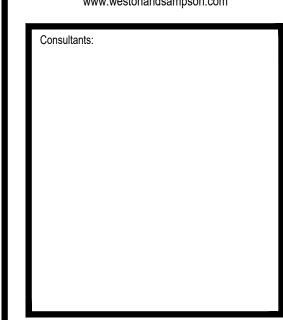WASHINGTON ST REPAIR LOCATIONS




TYPICAL MINOR SPALL REPAIR

SCALE: 1" = 1'-0"




TYPICAL PARTIAL DECK REPAIR

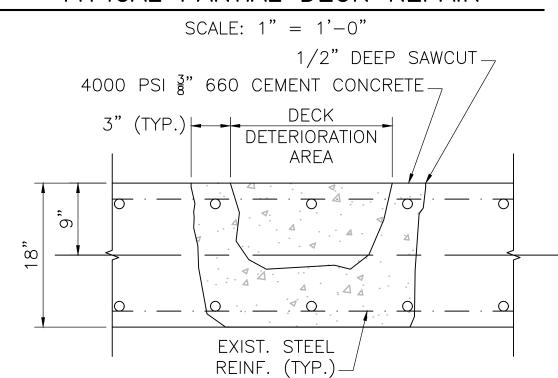


TYPICAL FULL DEPTH DECK REPAIR

SCALE: 1" = 1'-0"

- BRIDGE DECK REPAIR NOTES:
- 1. SPALLED, DELAMINATED, AND DETERIORATED CONCRETE DECK AREAS SHALL BE REPAIRED USING AN APPROVED RAPID SETTTING BAGGED CONCRETE PRODUCT, RAPID SETTING LOW PERMEABILITY MOBILE MIXED CONCRETE, OR HIGH EARLY STRENGTH READY MIX CONCRETE AS DIRECTED BY THE ENGINEER.
- 2. PARTIAL DECK REPAIRS: ALL DETERIORATED AND DELAMINATED CONCRETE SHALL BE REMOVED TO A MINIMUM OF 1" BELOW THE BOTTOM OF THE TOP LAYER OF EXISTING TRANSVERSE REINFORCEMENT STEEL TO A MAXIMUM OF 50% OF THE THICKNESS OF THE EXISTING CONCRETE DECK.
- 3. FULL DEPTH REAPIRS: ALL DETERIORATED AND DELAMINATED CONCRETE SHALL BE REMOVED, AND IF THE SOUND CONCRETE SURFACE IS LOCATED AT A DEPTH GREATER THAN 50% OF THE DECK THICKNESS WHEN MEASURED FROM THE TOP OF DECK, A FULL DEPTH DECK REPAIR SHALL BE PERFORMED.
- 4. ALL EXISTING REINFORCING STEEL AND CONCRETE SURFACES THAT ARE TO BE IN CONTACT WITH REPAIR CONCRETE SHALL BE ABRASIVELY BLAST CLEANED IN ORDER TO REMOVE ALL RUST, OIL, AND DEBRIS THAT IS NOT TIGHTLY ADHERED, FOLLOWED BY APPLICATION OF COMPRESSED AIR TO REMOVE ALL DUST.
- 5. NEW EPOXY COATED STEEL REINFORCEMENT SHALL BE PLACED TO SUPPLEMENT EXISTING REINFORCEMENT THAT HAS A SECTION LOSS OF 25% OR MORE OF THE ORIGINAL CROSS SECTION AREA OR HAS BROKEN, AS DETERMINED BY THE ENGINEER. NEW REINFORCEMENT SHALL EXTEND 30 BAR DIAMETERS IN EACH DIRECTION FROM WHERE THE SECTION LOSS OR BREAK ENDS. THE LIMITS OF THE REPAIR SHALL BE MODIFIED TO MEET THE REINFORCEMENT STEEL LAP SPLICE REQUIREMENTS. NEW REINFORCING STEEL SHALL BE PLACE AT THE SAME LEVEL ALONGSIDE THE EXISTING DETERIORATED OR BROKEN REINFORCING STEEL.

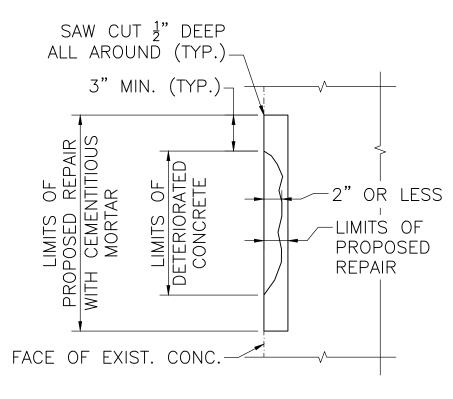

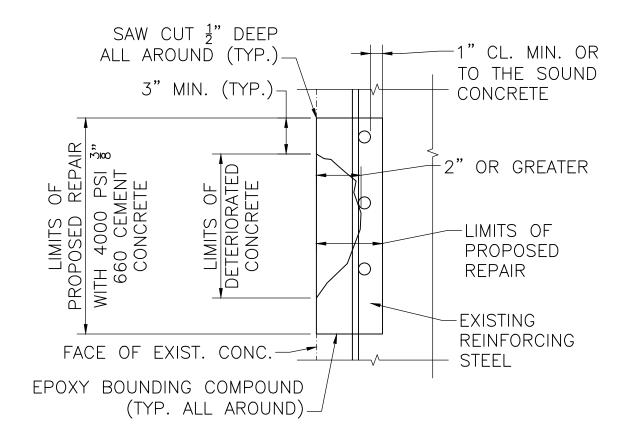


TYPE A SPALL REPAIR - LESS THAN 2" DEEP TYPE B SPALL REPAIR - MORE THAN 2" DEEP

SCALE: $1\frac{1}{2}$ " = 1'-0"

SCALE: $1\frac{1}{2}$ " = 1'-0"


- 1. CONTRACTOR TO PERFORM A FIELD SURVEY TO DETERMINE LIMITS OF DETERIORATION AND REQUIRES REPAIRS
- 2. AFTER APPROVAL OF LIMITS IS RECEIVED FROM THE ENGINEER, CONTRACTOR TO REMOVE DETERIORATED CONC. TO SOUND CONC. AT REPAIR LOCATIONS.
- 3. IF MORE THAN 50% OF A PIECE OF REINFORCING STEEL IS EXPOSED, THE CONCRETE SHALL BE REMOVED TO
- A MINIMUM OF 1" AROUND THE REINFORCING STEEL AS SHOWN ABOVE.
- 4. IF REINFORCING STEEL IS FOUND TO BE DETERIORATED, SUPPLEMENTARY REINFORCING STEEL IS TO BE
- 5. SUPPLEMENTARY REINFORCEMENT TO BE LAPPED WITH EXISTING REINFORCEMENT AS PER NOTES ON SHEET
- 6. CLEAN EXCAVATED CONCRETE SURFACE OF ALL DUST AND UNBONDED PARTICLES PRIOR TO REPAIR.
- 7. CONCRETE SURFACE SHALL BE DAMPENED PRIOR TO PATCHING IN ACCORDANCE WITH SPECIAL PROVISIONS.
- 8. IF LIMITS OF REPAIR IS LESS THAN 2" DEEP, TYPE A REPAIR IS TO BE PERFORMED AS SHOWN ABOVE.
- 9. IF LIMITS OF REPAIR IS MORE THAN 2" DEEP, TYPE B REPAIR IS TO BE PERFORMED AS SHOWN ABOVE 10. ALL PATCHES TO BE FINISHED FLUSH WITH SURROUNDING CONCRETE.

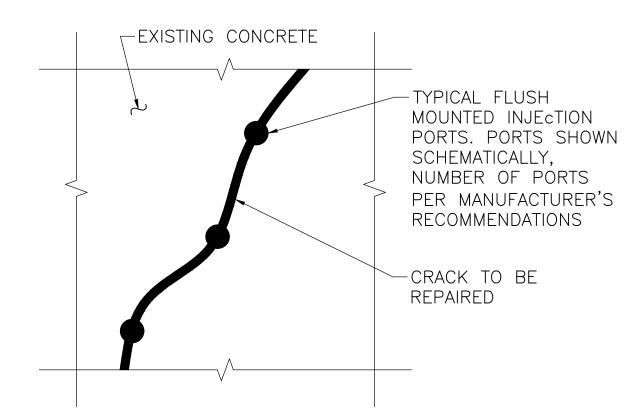

- 1. CONTRACTOR TO PERFORM FIELD SURVEY TO DETERMINE LIMITS OF CRACKS AND REQUIRED REPAIRS (SEE NOTES ON SHEET S1).
- 2. AFTER APPROVAL OF LIMITS IS RECIEVED FROM THE ENGINEER, CONCRETE CRACKS SHALL BE REPAIRED BY EPOXY INJECTION.
- 3. CRACKS SHALL BE CLEANED IN ACCORDANCE WITH THE PROJECT
- SPECIFICATIONS PRIOR TO INSTALIATION OF INJECTION PORTS.
- 4. REFER TO SPECIAL PROVISIONS FOR MATERIAL AND ADDITIONAL PROCEDURE REQUIREMENTS.

EPOXY INJECTION CRACK REPAIR DETAIL

NOT TO SCALE

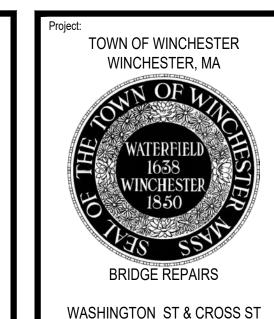

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Drawing Title:

REPAIR DETAILS

Sheet Number:

S-2



TOWN OF WINCHESTER WINCHESTER, MA

WATERFIELD
1638
WINCHESTER
1850

BRIDGE REPAIRS

WASHINGTON ST & CROSS ST
OVER ABERJONA RIVER

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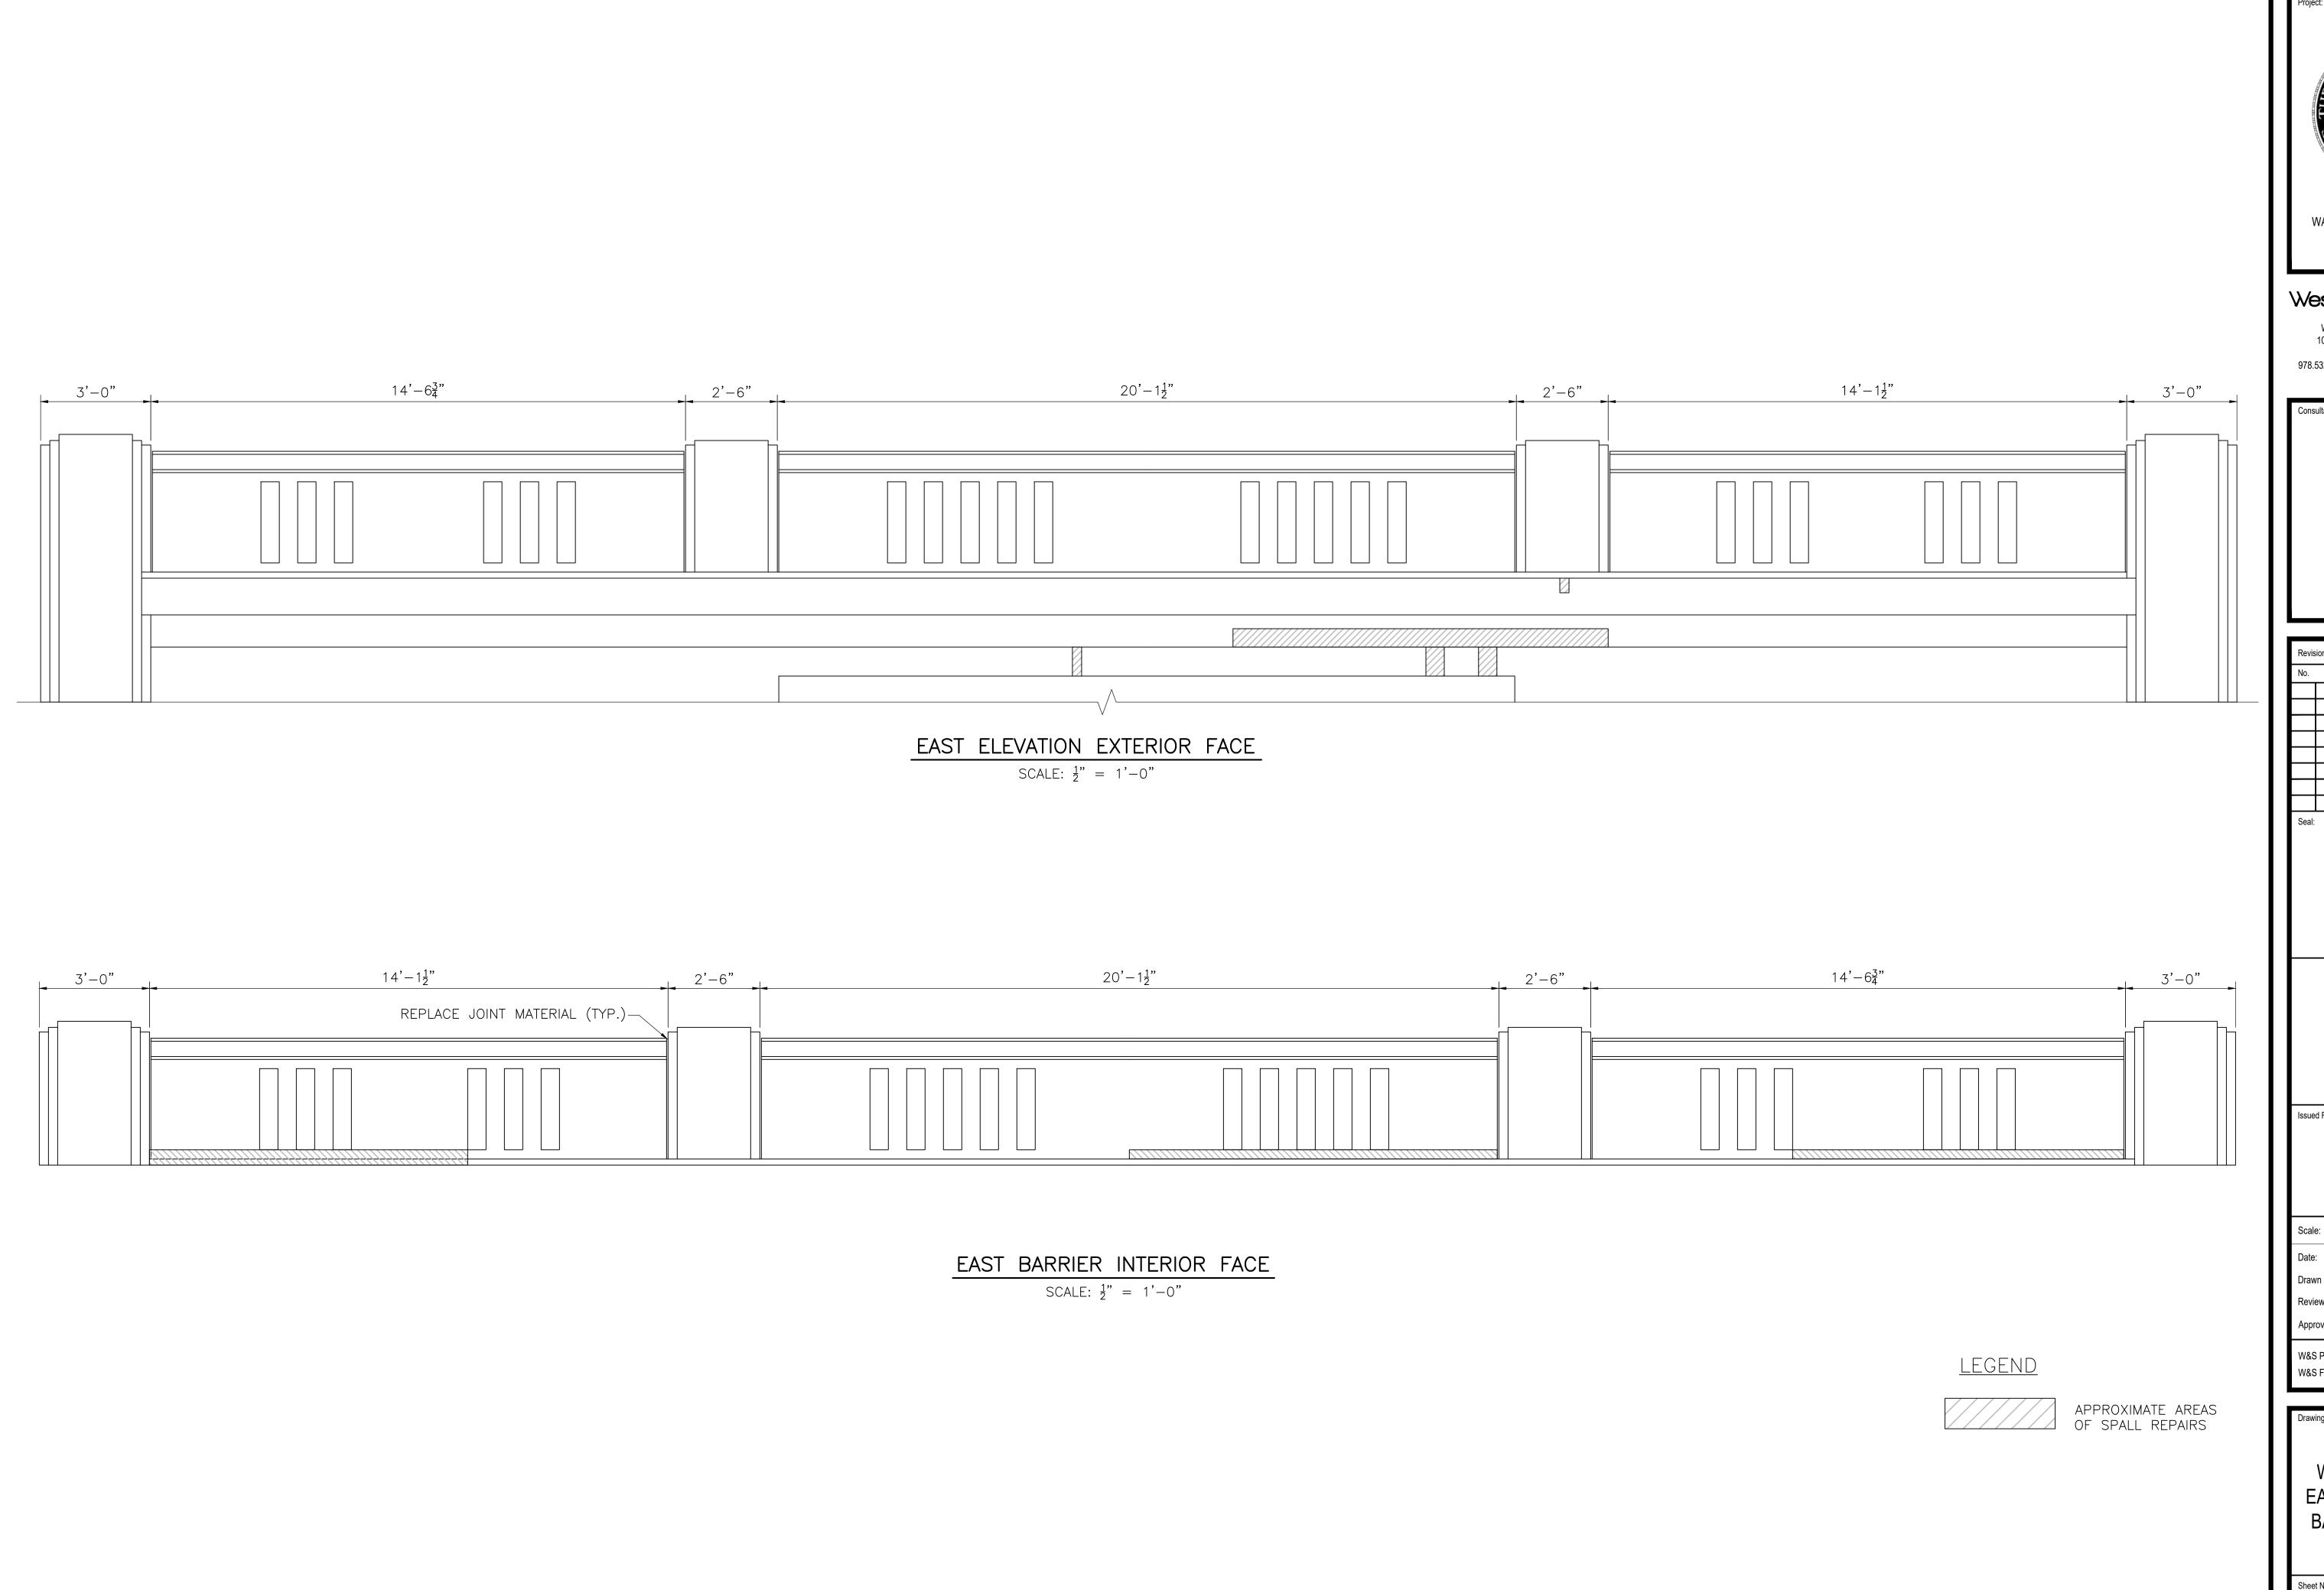
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Drawn By:	YS
Reviewed By:	XXX
Approved By:	XXX
W&S Project No.:	ENG21 - 1288

Drawing Title:

WASHINGTON ST WEST ELEVATION & BARRIER REPAIRS

Sheet Number:

S-4




TOWN OF WINCHESTER WINCHESTER, MA WASHINGTON ST & CROSS ST OVER ABERJONA RIVER

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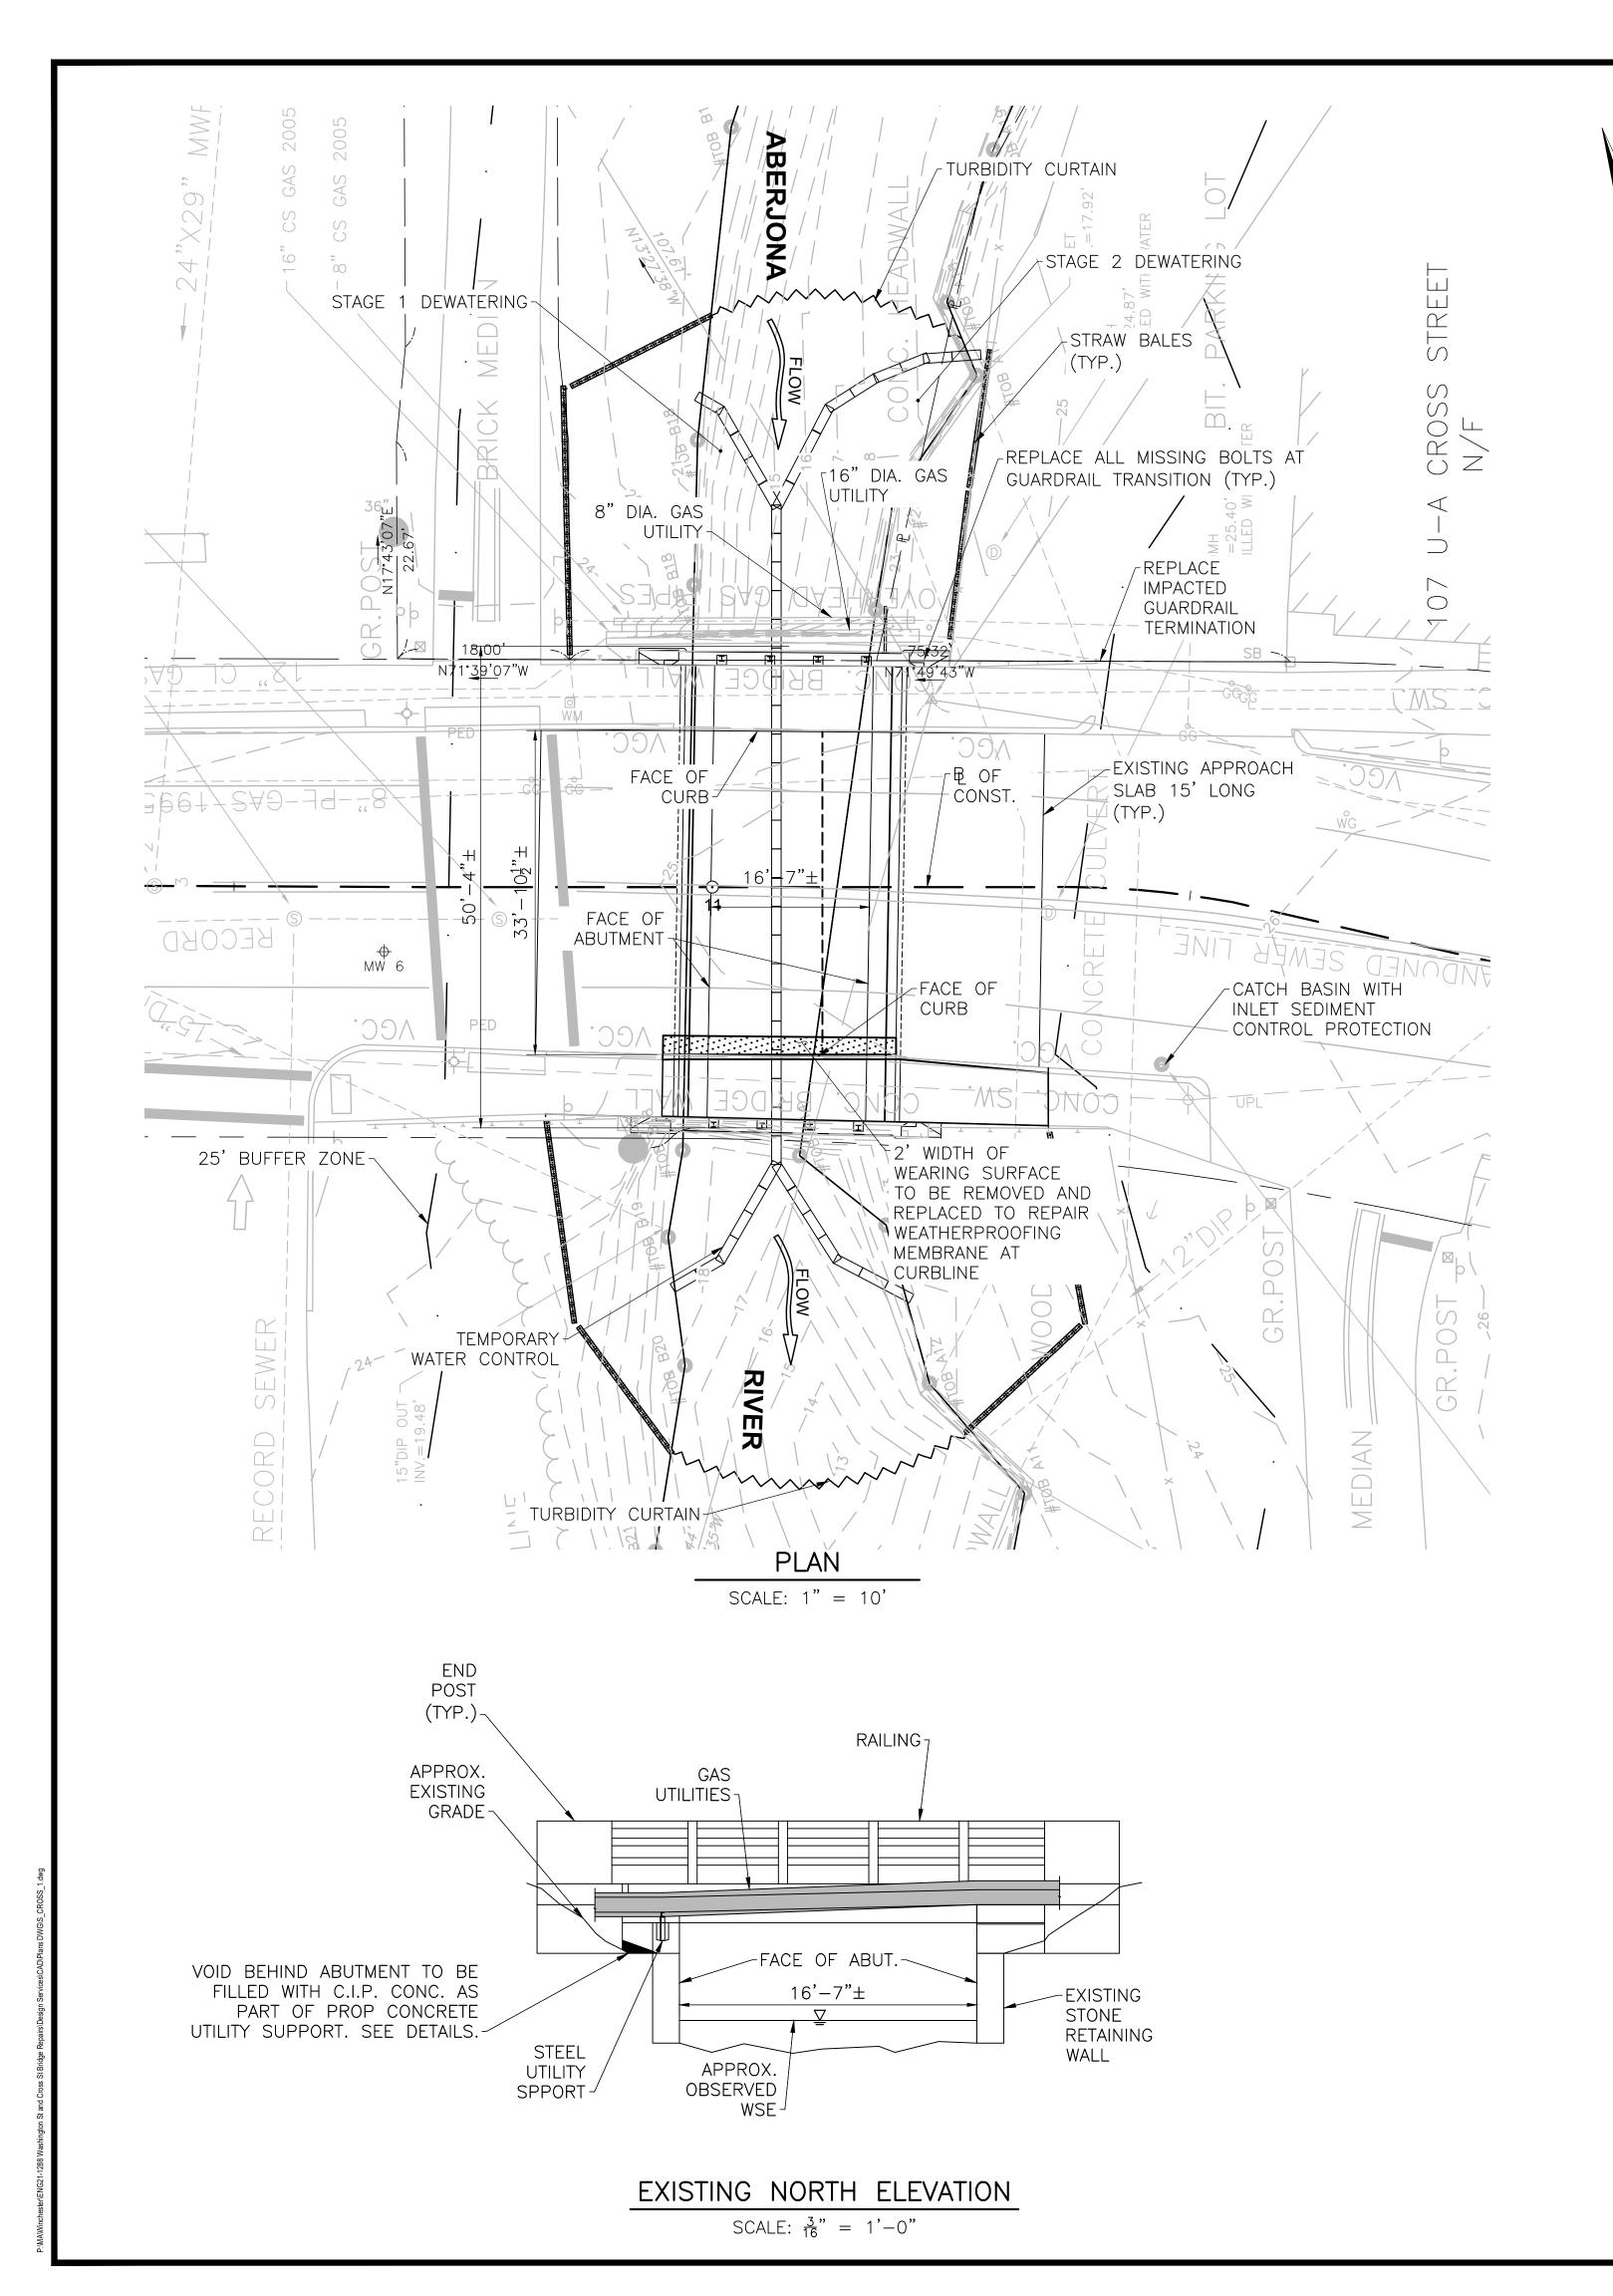
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W&S Project No.: W&S File No.:	ENG21 - 1288

WASHINGTON ST EAST ELEVATION & BARRIER REPAIRS

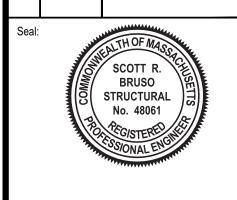

GENERAL NOTES

EXISTING CONDITIONS:

DIMENSIONS SHOWN AND DETAILS DEPICTED ARE NOT GUARANTEED. THE CONTRACTOR SHALL DETERMINE AND ESTABLISH ALL DIMENSIONS AND DETAILS NECESSARY FOR COMPLETION OF ALL WORK BY FIELD MEASUREMENT AND SURVEY. THE CONCTRACTOR SHALL BE RESPONSIBLE AND NOT ORDER ANY MATERIAL OR COMMENCE ANY FABRICATION UNTIL THE REQUIRED MEASUREMENTS ON THE EXTENT OF THE PROPOSED WORK HAS BEEN APPROVED BY THE ENGINEER.

EXISTING PLANS:

IF REQUIRED, ORIGINAL PLANS FOR THE EXISTING BRIDGE, DATED 1995 MAY BE SEEN AT THE OFFICE OF THE BRIDGE ENGINEER, MASSDOT — HIGHWAY DIVISION. 10 PARK PLAZA, BOSTON, MASSACHUSETTS.

<u>CONCRETE:</u>


ALL CEMENT CONCRETE SHALL BE AS SPECIFIED BELOW: 4000 PSI, \(\frac{3}{4}\)" 585 HP CEMENT CONCRETE

FIELD SURVEY:

PRIOR TO COMMENCEMENT OF ANY REPAIR WORK, THE CONTRACTOR SHALL PERFORM FIELD SURVEY TO DETERMINE AND MARK OUT THE EXTENTS OF ALL DETERIORATION AND REPAIRS TO BE PERFORMED. FIELD SURVEY SHALL INCLUDE SOUNDING FOR DELAMINATION AND KNOCKING OFF LOOSE CONCRETE VIA HAMMER TAPPING. THE CONTRACTOR MUST THEN RECIEVE APPROVAL OF ALL DETERIORATION AND REPAIR EXTENTS BY THE ENGINEER PRIOR TO THE COMMENCEMENT OF REPAIR WORK. THE ENGINEER SHALL HAVE FINAL SAY ON ALL LIMITS OF DETERIORATION AND REPAIRS.

TEMPORARY WATER CONTROL:


COFFERDAM FOR STAGE 1 DEWATERING MUST BE REMOVED BEFORE COFFERDAM FOR STAGE 2 DEWATERING IS INSTALLED.

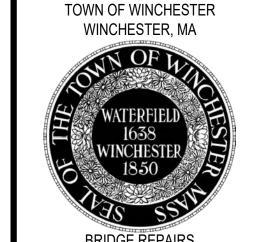

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No.	Date	Description
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STRUCTURAL No. 48061

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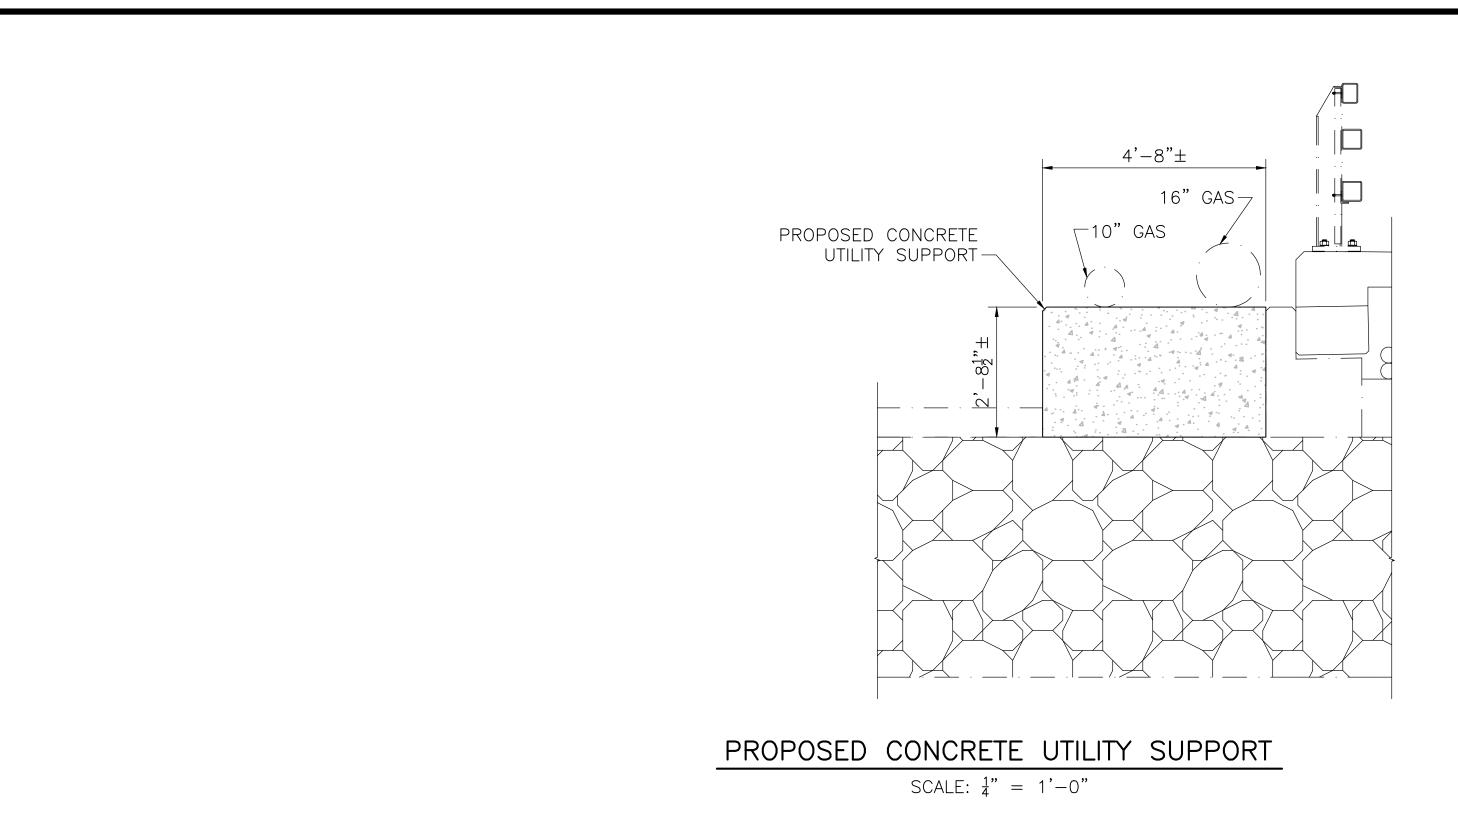
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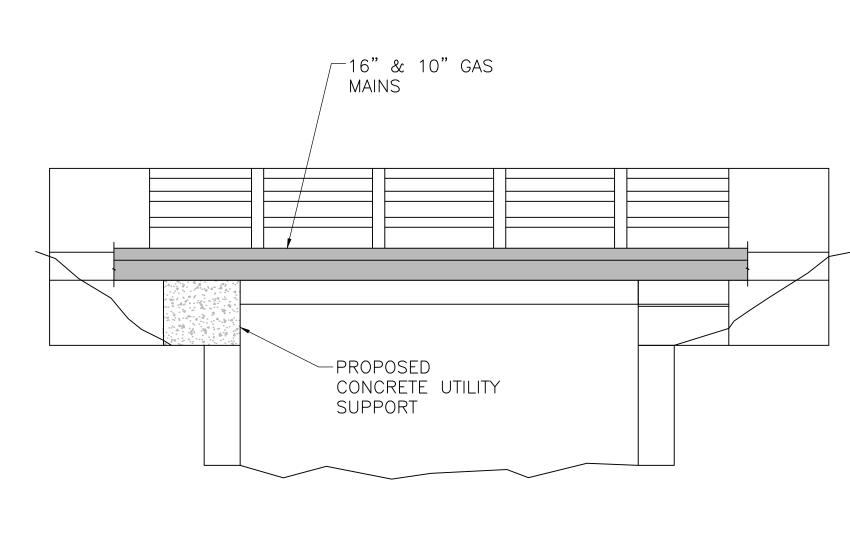
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CROSS ST PLAN AND ELEVATION


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S-6

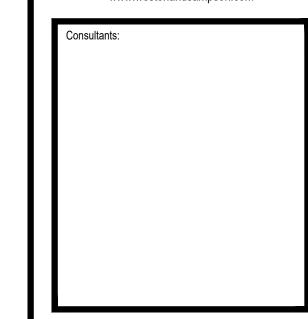





PROPOSED NORTH ELEVATION SCALE: $\frac{1}{4}$ " = 1'-0"

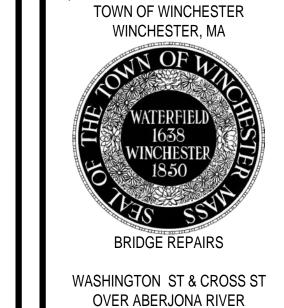

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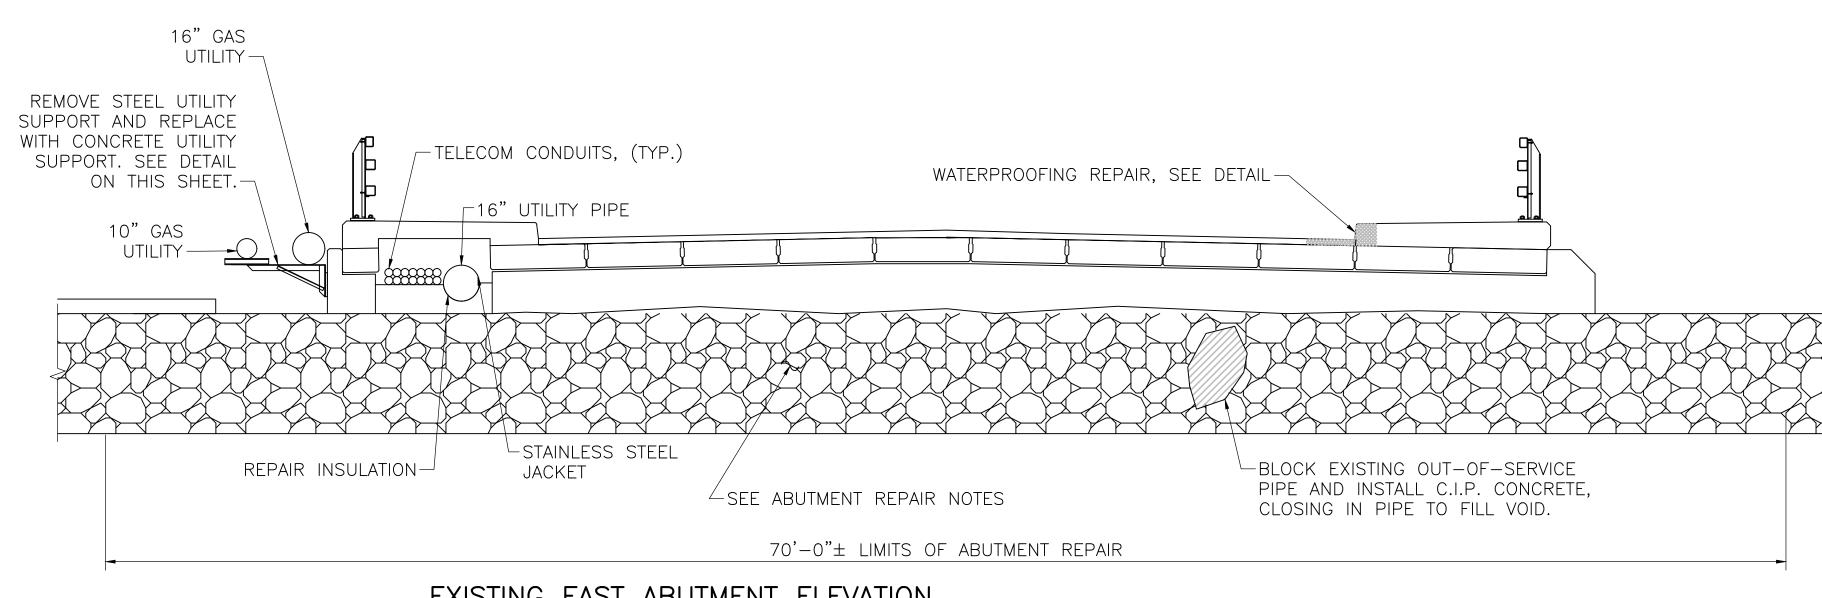


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ABUTMENT ELEVATIONS AND REPAIR DETAILS

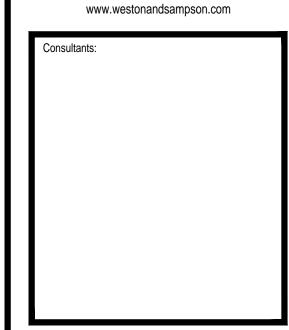

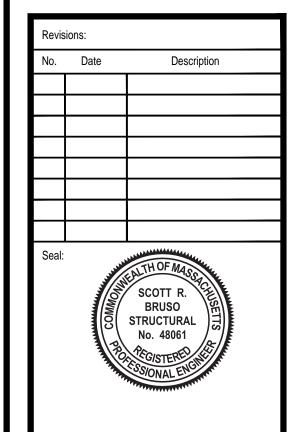EXISTING EAST ABUTMENT ELEVATION

ABUTMENT REPAIR NOTES:

JOINTS.


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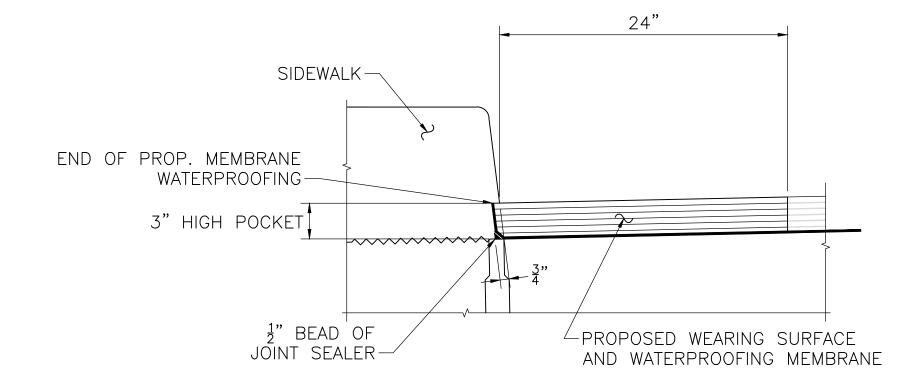
2. REPOINT LOOSE OR CRACKED MORTAR

3. INSTALL C.I.P. CONCRETE IN LOCATIONS

WITH VOIDS EXCEEDING 6" DEEP.

SCALE: $\frac{1}{4}$ " = 1'-0"



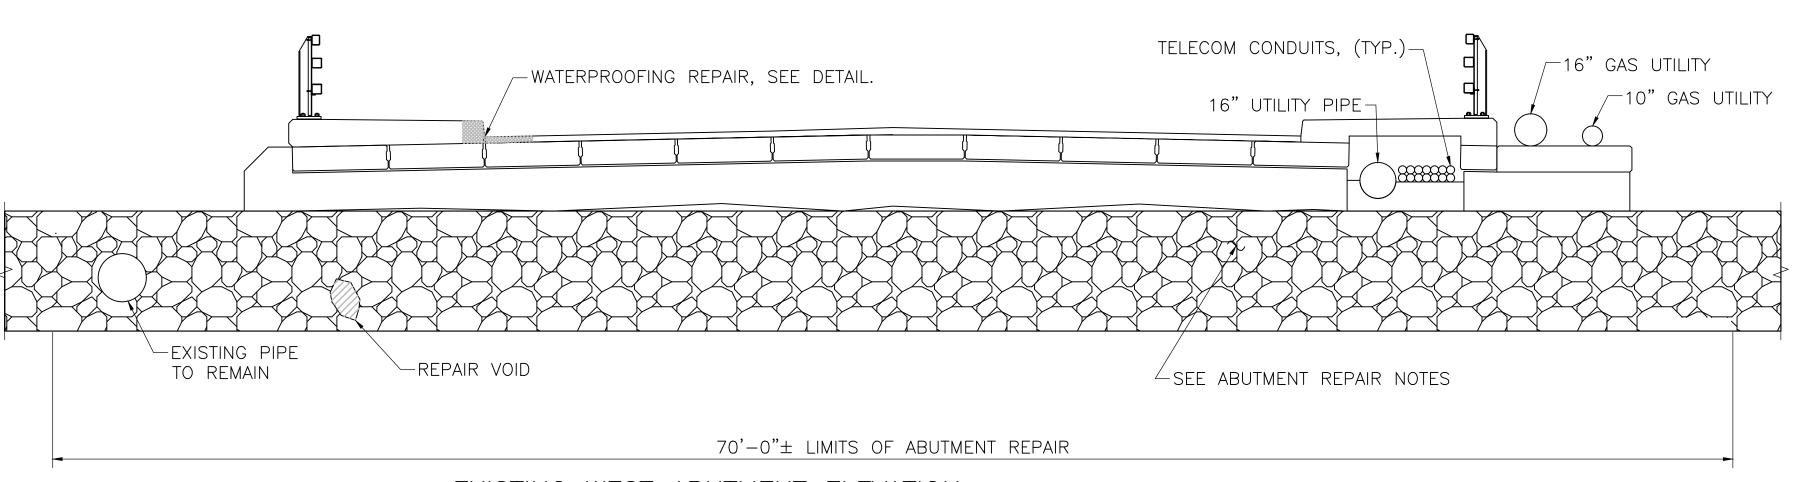

SIDEWALK DETAIL SCALE: $\frac{1}{4}$ " = 1'-0"

EXISTING WEST ABUTMENT ELEVATION

SCALE: $\frac{1}{4}$ " = 1'-0"